

SCALE: 1' = 1'-0" (2)-

MERCER ISLAND ZONING CODE DATA

ZONE:	R-8.4
ECA	STEEP SLOPE
	LANDSLIDE HAZARD
	SEISMIC HAZARD
SETBACKS:	(NO CHANGE TO EXISTING, LEGALLY PERMITTED
	CONFIGURATION)

HEIGHT LIMIT:

GFA CALCULATIONS

PROJECT WAS LEGALLY CONFORMING AT TIME OF CONSTRUCTION BUT EXCEEDS CURRENT STANDARDS FOR GFAALLOWANCES.

30'-0" A.B.E.

THE SCOPE OF THIS PROJECT CONVERTS 177 SF FROM A DOUBLE-HEIGHT SPACE (200% GFA CONTRIBUTION) TO A NEW LOFT SPACE ABOVE A SINGLE-HEIGHT SPACE (EACH AT 100% GFA CONTRIBUTION) FOR NO CHANGE TO GFA UNDER CURRENT STANDARDS. (STRATEGY AFFIRMED BY PERMIT COUNTER COACH ROBIN PROEBSTING.)

SITE AREA	10,574 SF
ALLOWED GFA:	LESSER OF 40% (4,229.6 SF) OR 5,000 SF
ADU PRESENT?	YES
ADU BONUS:	LESSER OF 45% (4,758 SF) OR 4,500 SF
ALLOWED GFA:	4,500 SF
GFA CALC RULES:	150% WHERE CEILING 12-16 FT
	200% WHERE CEILING 16+ FT
	STAIRCASES COUNT ONCE FOR TWO STORIES

BUILDING AREA CALCULATIONS

BASEMENT (E) BELOW GRADE (E) ABOVE GRADE (E)	119 SF @ 0% GFA 1,144 SF
FIRST FLOOR (E)	1,791 SF
AREA OF DBL HT SPACE (E):	352 SF @ 200% GFA
TOTAL GFA (E):	2,143 SF
REDUCTION FOR LOFT:	177 SF @ 100% GFA
TOTAL GFA (NEW):	1,966 SF
SECOND FLOOR (E)	1,920 SF
NEW LOFT	177 SF @ 100% GFA
TOTAL GFA (NEW):	2,097 SF
GARAGE	482 SF
TOTAL GFA (E)	5,689 SF
TOTAL GFA (NEW)	5,689 SF (NO CHANGE)

182.03'

212.03' (30')

208.927 (26.8')

211.78 (29.75)

HEIGHT CALCULATIONS

А	27.5	173.5	4771.25	ABE
D	21.5	173.5	3730.25	MAX HEIGHT
Е	12.18	178.45	2173.521	EXISTING HT
F	6.74	178.35	1202.079	NEW BLDG HT
G	2.9	178.25	516.925	
Н	11.99	179.2	2148.608	
I	2.9	180.5	523.45	
J	6.62	180.5	1194.91	
K	11.97	183.3	2194.101	
L	8.38	183.9	1541.082	
М	33.84	184.5	6243.48	
Ν	22.21	190.4	4228.784	
0	83.33	185	15416.05	
тот	252.1		45884.49	

PROJECT INFORMATION

PROJECT DESCRIPTION:

* NEW ROOF DECK & ROOF ACCESS PENTHOUSE; * NEW INTERIOR IMPROVEMENTS, INCLUDING NEW FLOOR AREA CONVERTING EXISTING DBL-HT SPACE TO SINGLE-HT SPACE; AND OTHER MINOR INTERIOR IMPROVEMENTS.

OWNER: ADDRESS LEGAL:

YANGFAN XU 5850 W Mercer Way Mercer Island WA 98040

CHRISTIAN CHURCH CAMP ADD #2 LOT 12 LESS N 23 FT LESS E 61 FT THOF TGW LOT 13 LESS S 15.22 FT AS MEAS ALG E LN SD LOT 13 LESS E 61 FT THOF AKA PAR D MI LOT LN REV 84-06-21 REC NO 8504159001

PARCEL SITE AREA 1574700190 10,574 SF

PROJECT TEAM

OWNER:

YANGFAN XU 5850 W Mercer Way Mercer Island WA 98040 206-999-9583 dxulander@gmail.com

ARCHITECT:

BRETT HOLVERSTOTT AIR MOD ARCHITECTURE 10330 126TH AVE SE RENTON WA 98056 206-251-8947 brett@air-mod.com

STRUCTURAL:

KEITH RYAN TSE ENGINEERING 12810 NW 178TH ST. STE 218 WOODINVILLE, WA 98072 425-481-6601 keith@tse-aep.com

TREE PROTECTION INFORMATION

1. NO TREES ON SITE TO BE REMOVED

2. NO VEHICULAR TRAFFIC, EQUIPMENT OR MATERIAL STORAGE TO OCCUR OFF EXISTING PAVED SURFACES.

3. NO PRUNING SHALL BE PERFORMED UNLESS UNDER THE DIRECTION OF AN ARBORIST

4.PROVIDE TREE PROTECTION FENCE ALONG EXISTING PAVED SURFACES SERVING CONSTRUCTION VEHICLE TRAFFIC.

5. NO GROUND DISTURBANCE TO OCCUR WITH THIS PERMIT.

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Sections		
	A-301	Building Section
	A-302	Stair Sections
_ /		
Details		
	A-501	Details

ARCHITECTURE PLLC	
brett@air-mod.com 206-251-8947 air-mod.com	
CONSULTANTS	
REGISTERED ARCHITECT BRETT HOLVERSTOTT STATE OF WASHINGTON	
XU REMODEL 5850 W MERCER WAY MERCER ISLAND WA 90840	
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5850 W N	
PROJECT NO: 2019-03 MODEL FILE: Xu Remodel.pln DRAWN BY: BH COPYRIGHT:	
SHEET TITLE Cover Sheet	
G-001	

SHEET 37

OF 55

LEGAL DESCRIPTION

(PER STATUTORY WARRANTY DEED REC. NO. 20140116000521)

THAT PORTION OF LOTS 12 AND 13, BLOCK 9, CHRISTIAN CHURCH COMMUNITY CAMP DIVISION NO. 2, ACCORDING TO THE PLAT THEREOF, RECORDED IN VOLUME 31 OF PLATS, PAGE 42, IN KING COUNTY, WASHINGTON, DESCRIBED AS FOLLOWS:

COMMENCING AT THE SOUTHWEST CORNER OF LOT 12, ISLAND GLEN, ACCORDING TO THE PLAT THEREOF, RECORDED IN VOLUME 88 OF PLATS, PAGE 72, IN KING COUNTY, WASHINGTON; THENCE NORTH 89°53'23" WEST 92.04 FEET TO THE TRUE POINT

THENCE CONTINUING NORTH 89°53'24" WEST PARALLEL TO THE SOUTH LINE OF SAID LOT 13, A DISTANCE OF 176.47 FEET TO THE WEST LINE OF SAID LOTS 12 AND 13, BEING A POINT ON A CURVE, THE CENTER OF WHICH BEARS NORTH 80°02'54" WEST, 1462.69 FEET;

THENCE NORTHERLY ALONG SAID WEST LINE ON A CURVE TO THE LEFT. AN ARC DISTANCE OF 62.38 FEET;

NORTH 23.00 FEET OF LOT 12, SAID BLOCK 9, A DISTANCE OF 166.90 FEET;

EAST 61.00 FEET OF SAID LOTS 61.67 FEET TO THE TRUE POINT OF BEGINNING

(ALSO KNOWN AS LOT D, MERCER ISLAND LOT LINE REVISION NO. MI-84-06-21, RECORDED UNDER RECORDED NO. 8504159001)

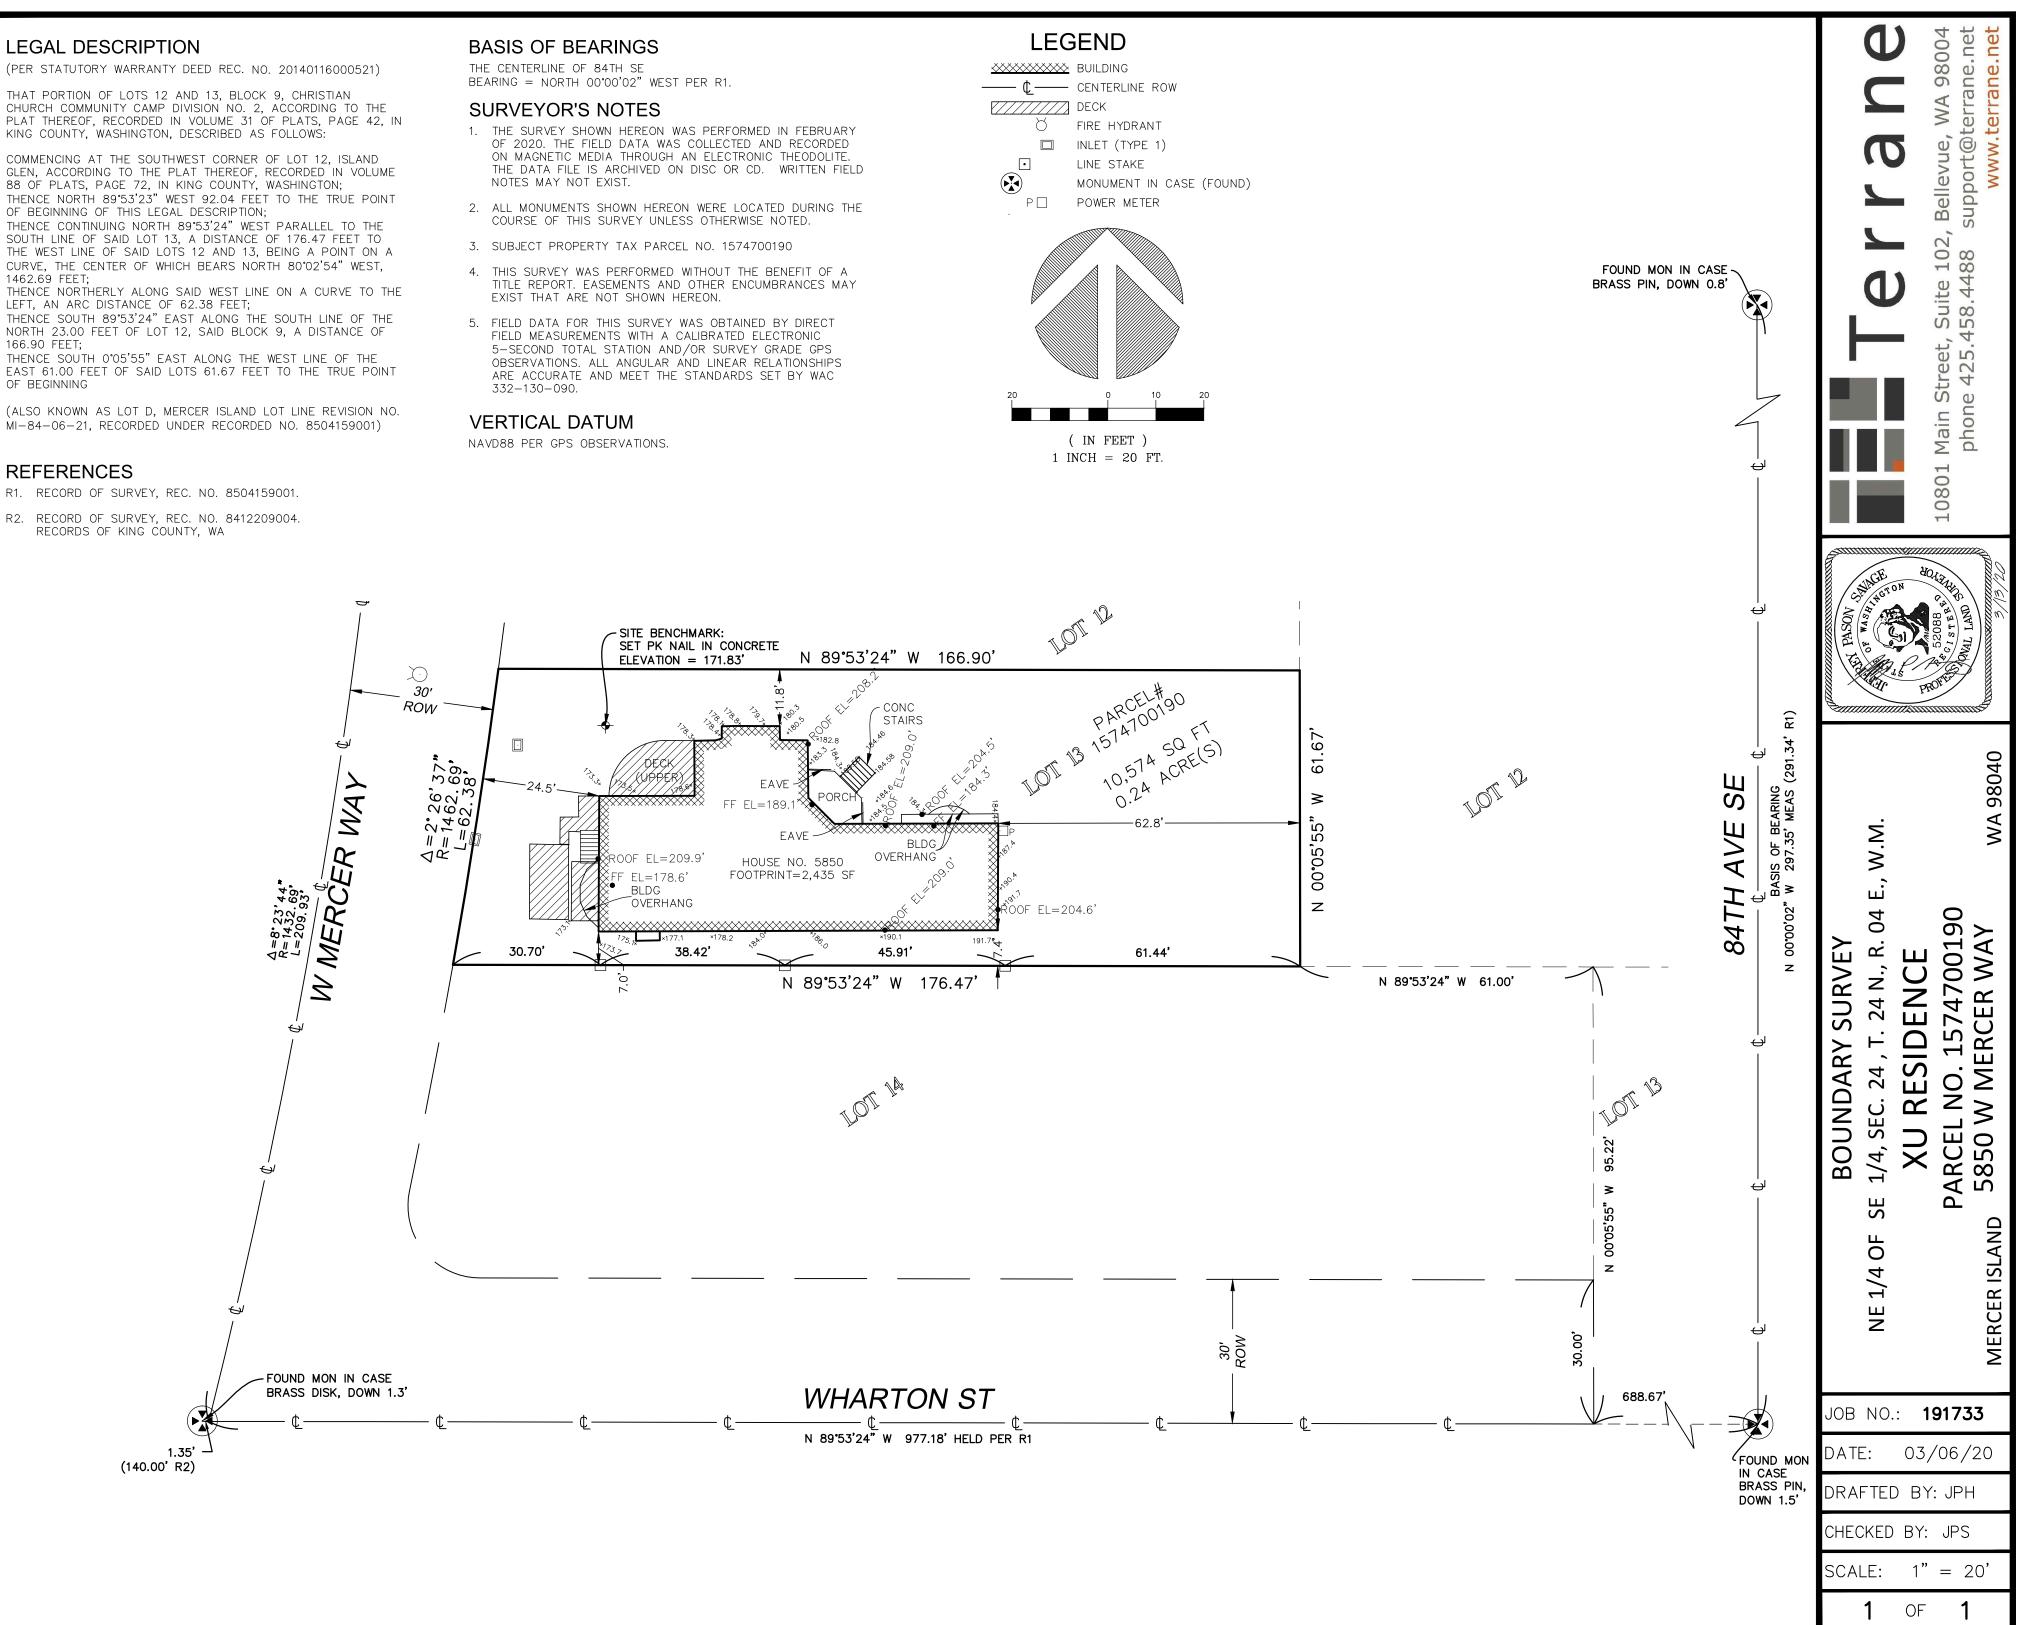
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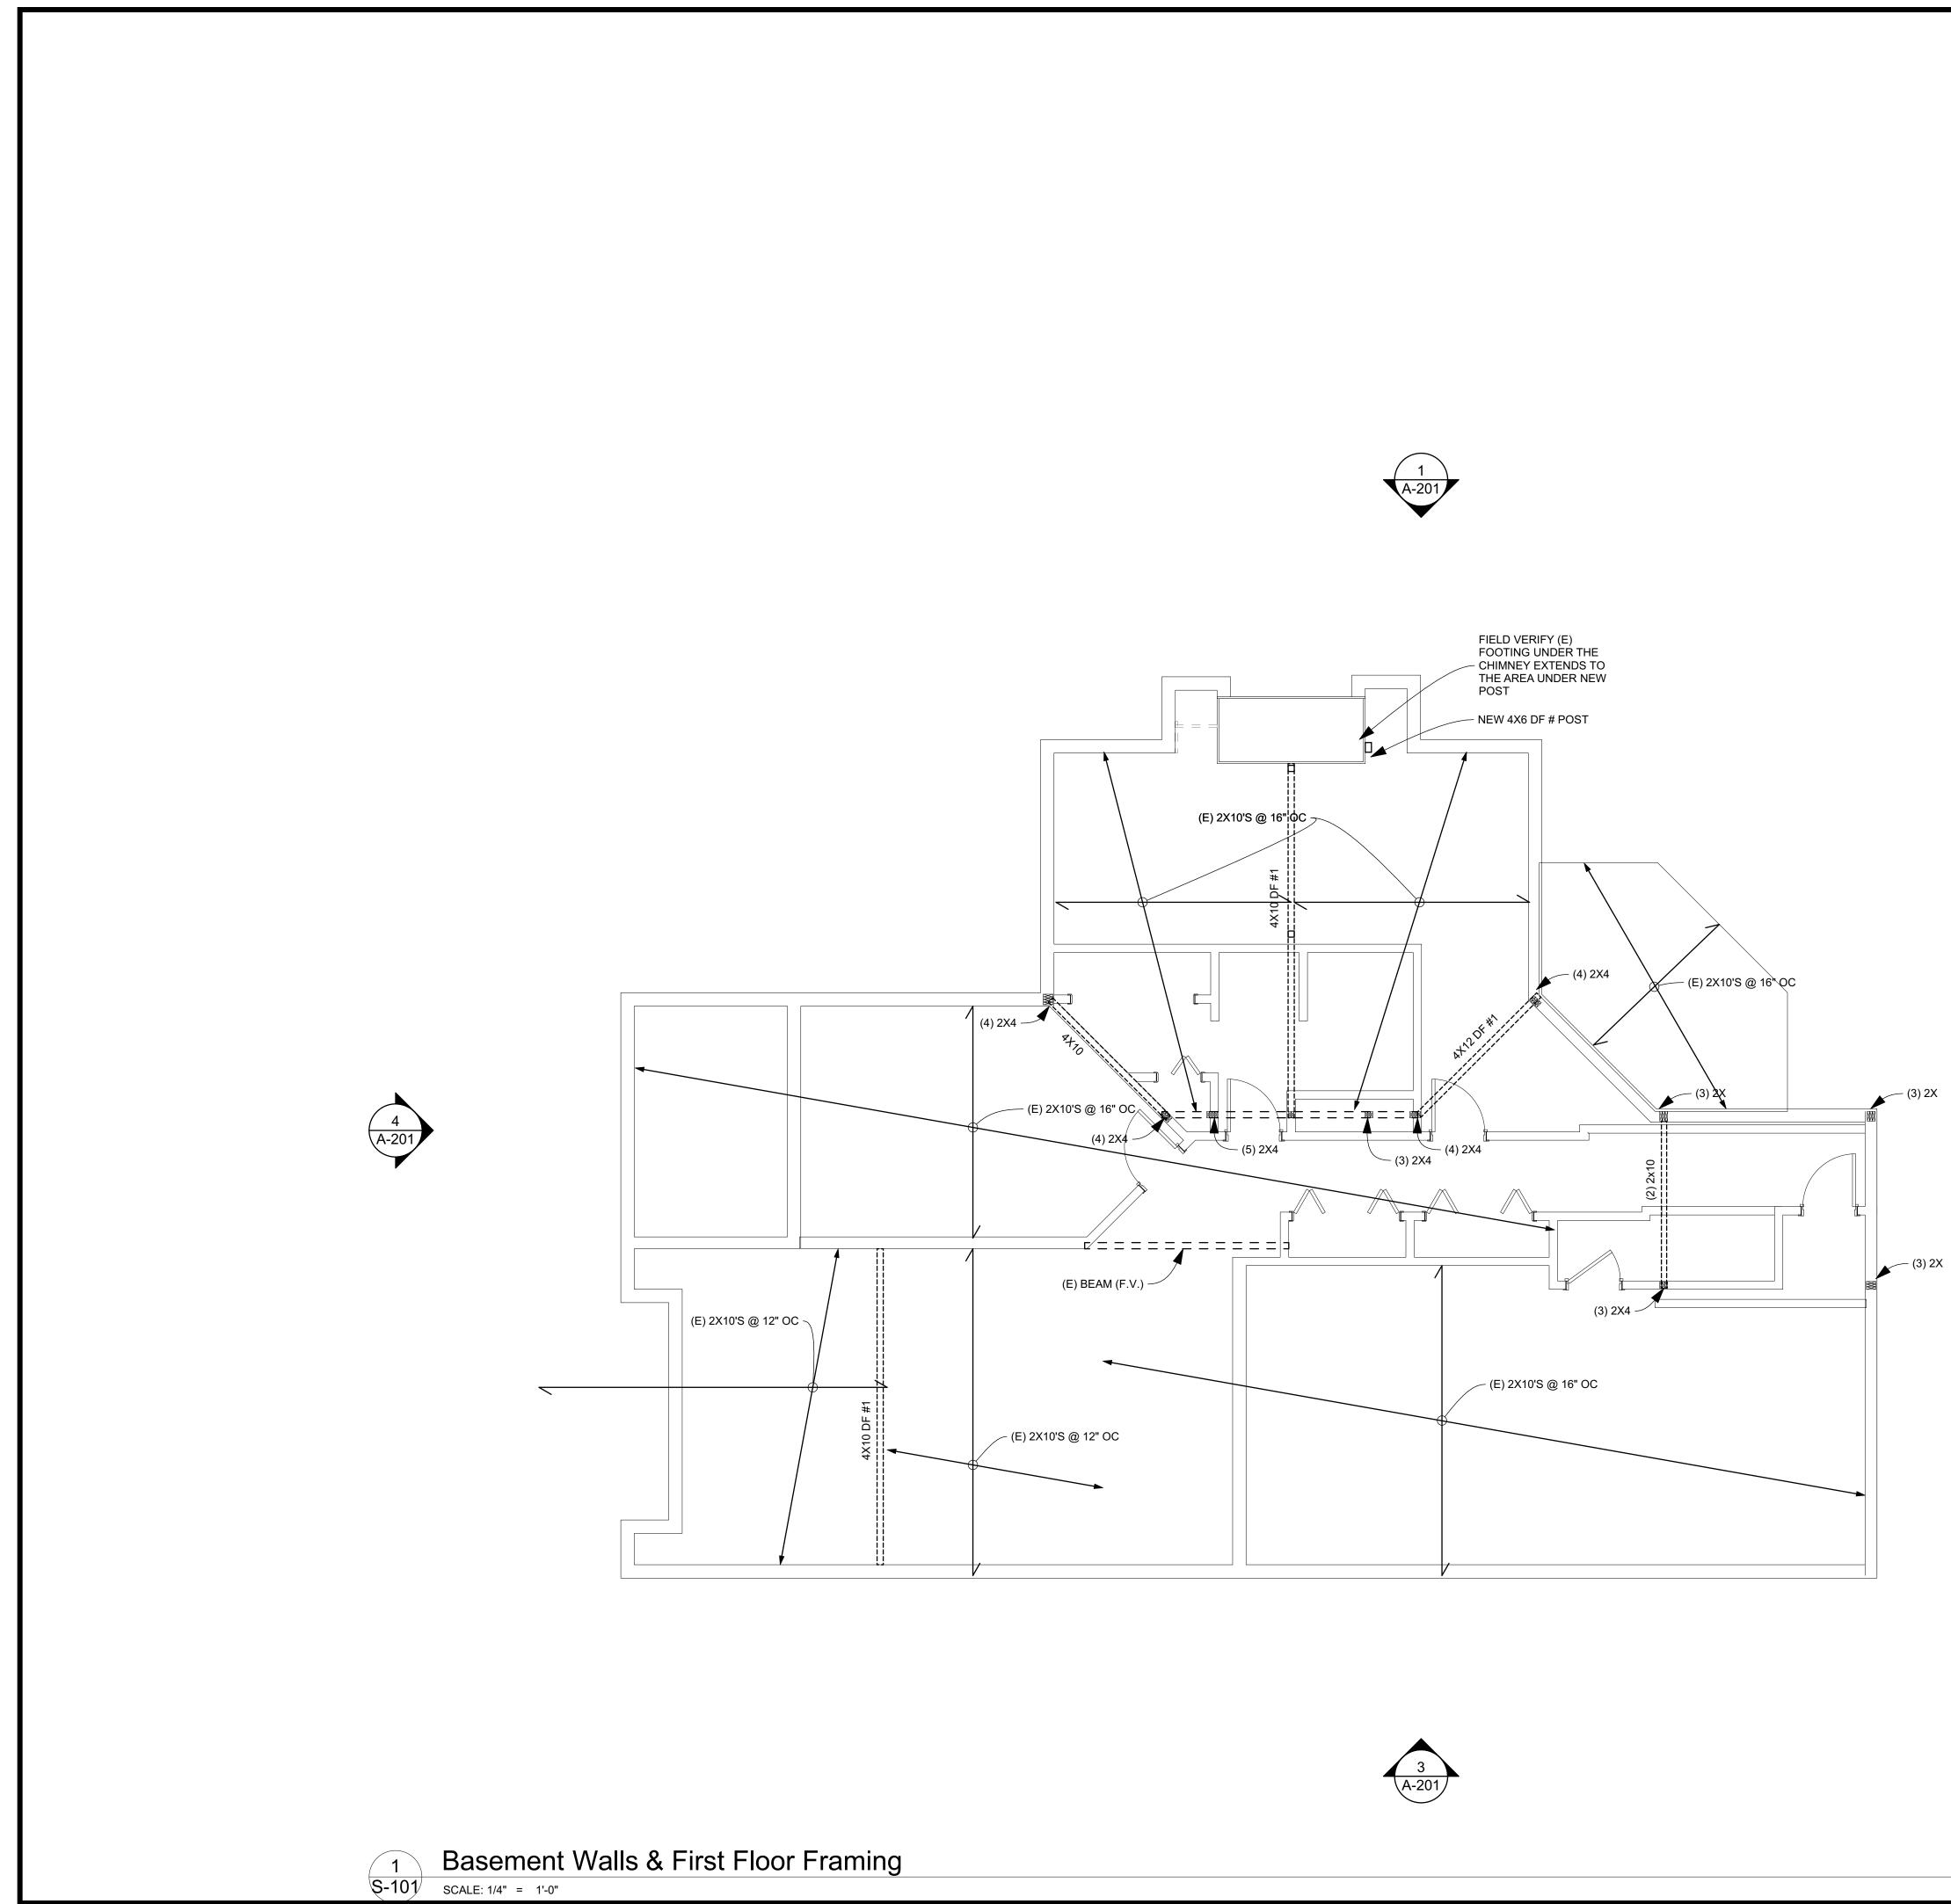
R1. RECORD OF SURVEY, REC. NO. 8504159001.

R2. RECORD OF SURVEY, REC. NO. 8412209004.

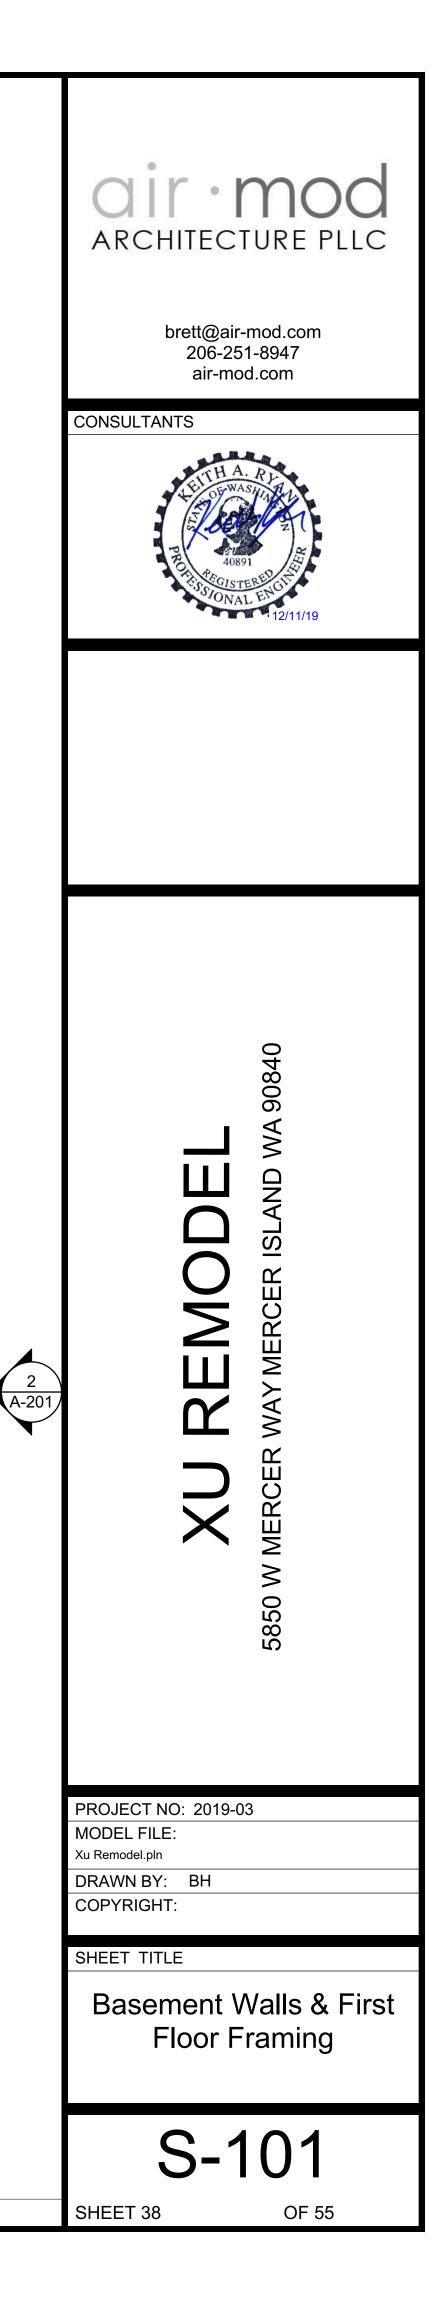
- OF 2020. THE FIELD DATA WAS COLLECTED AND RECORDED ON MAGNETIC MEDIA THROUGH AN ELECTRONIC THEODOLITE. NOTES MAY NOT EXIST.

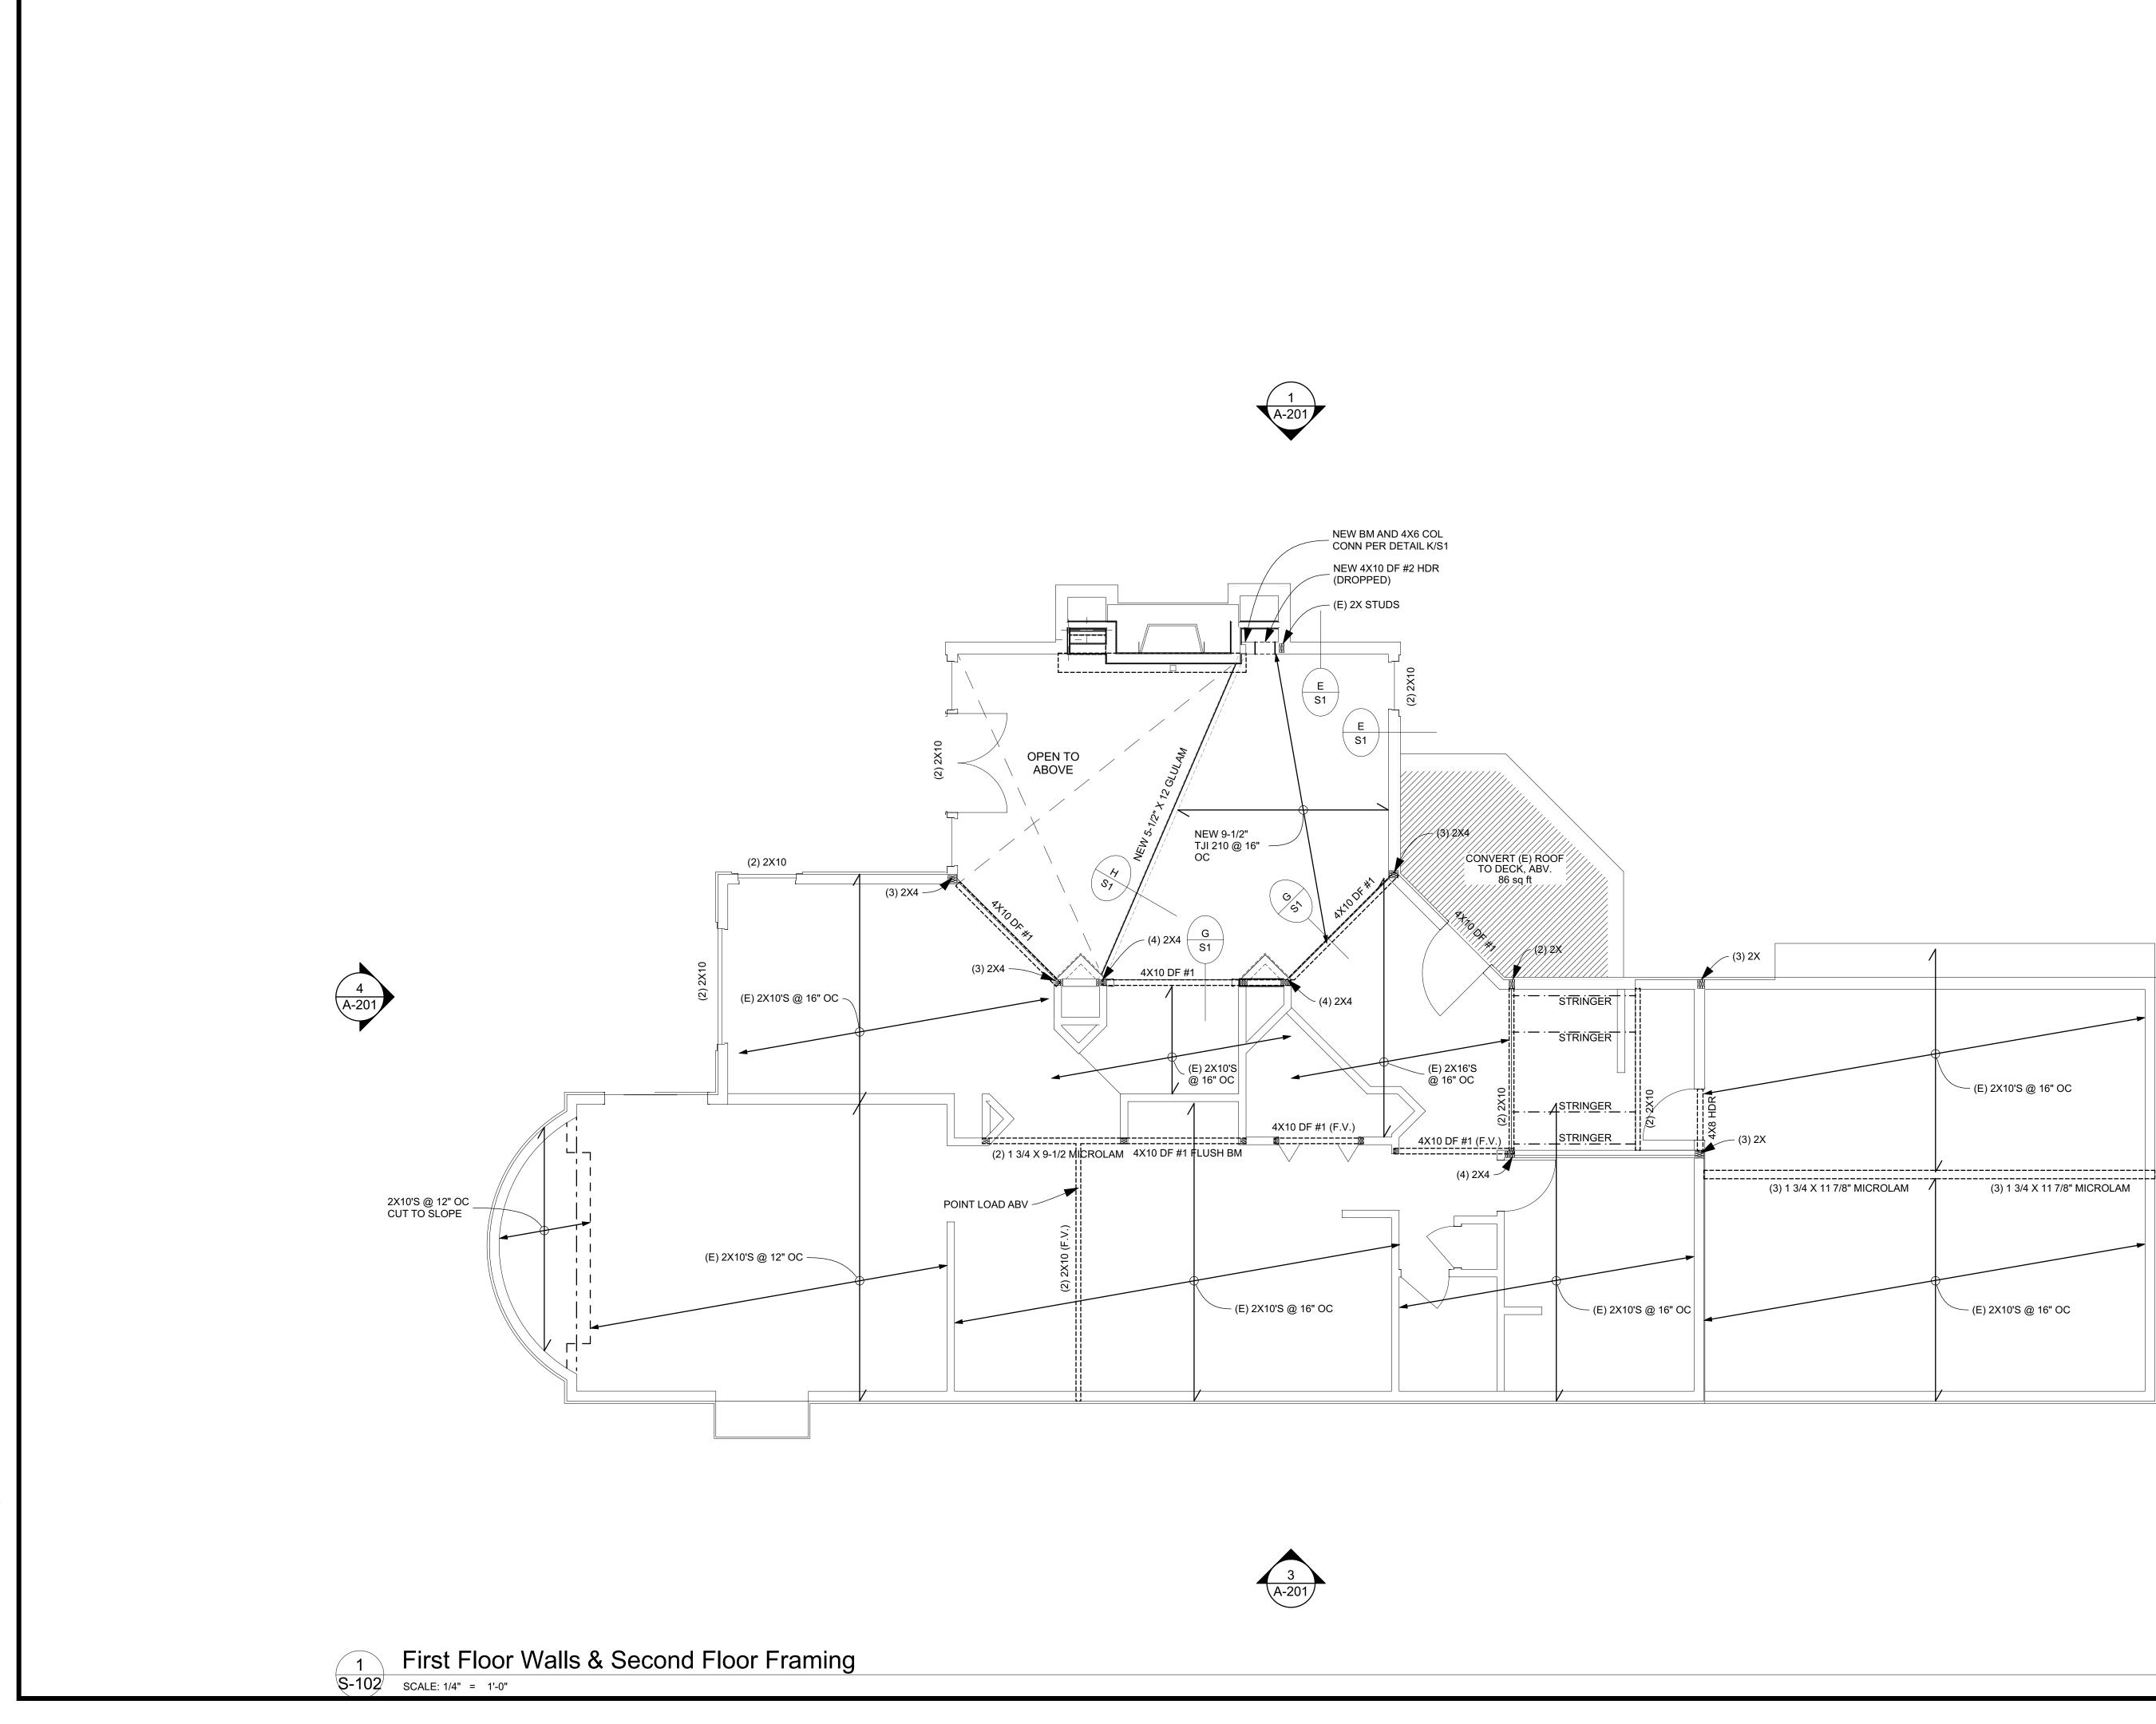
- FIELD MEASUREMENTS WITH A CALIBRATED ELECTRONIC 5-SECOND TOTAL STATION AND/OR SURVEY GRADE GPS ARE ACCURATE AND MEET THE STANDARDS SET BY WAC 332-130-090.



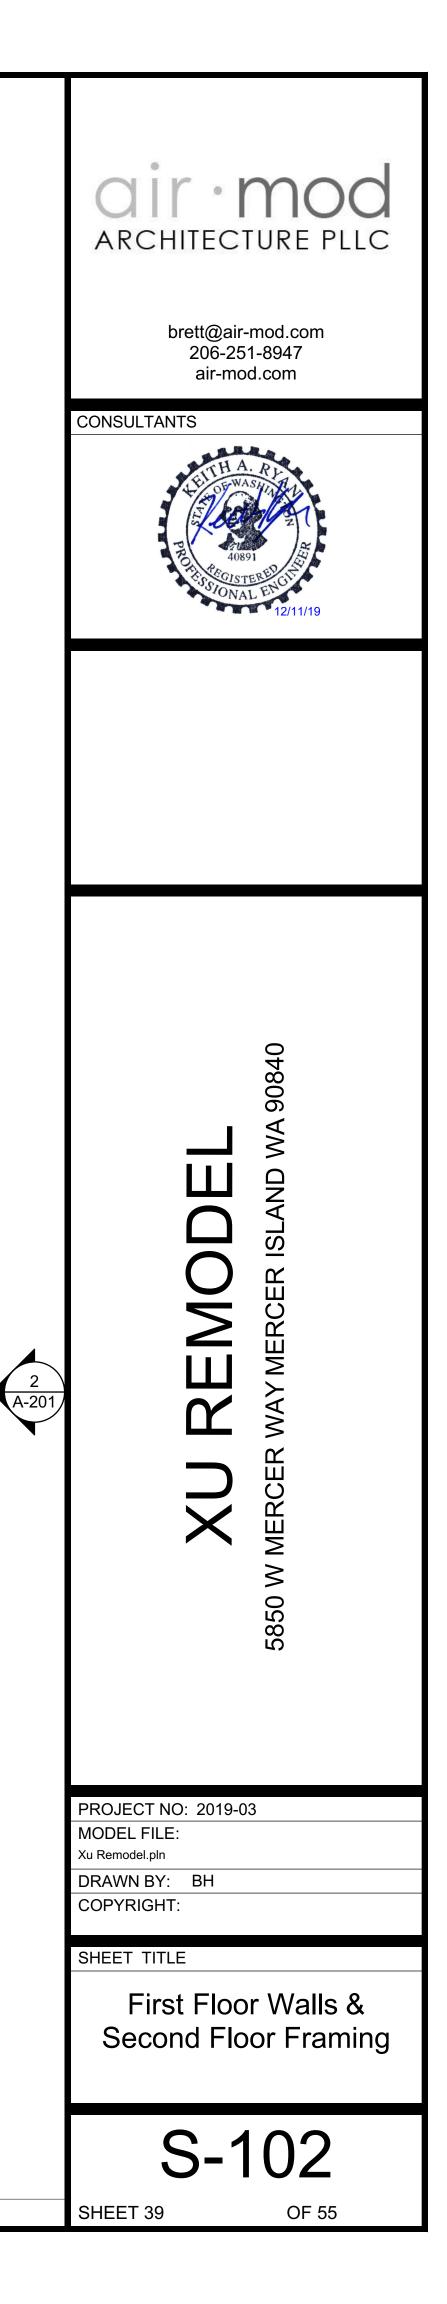


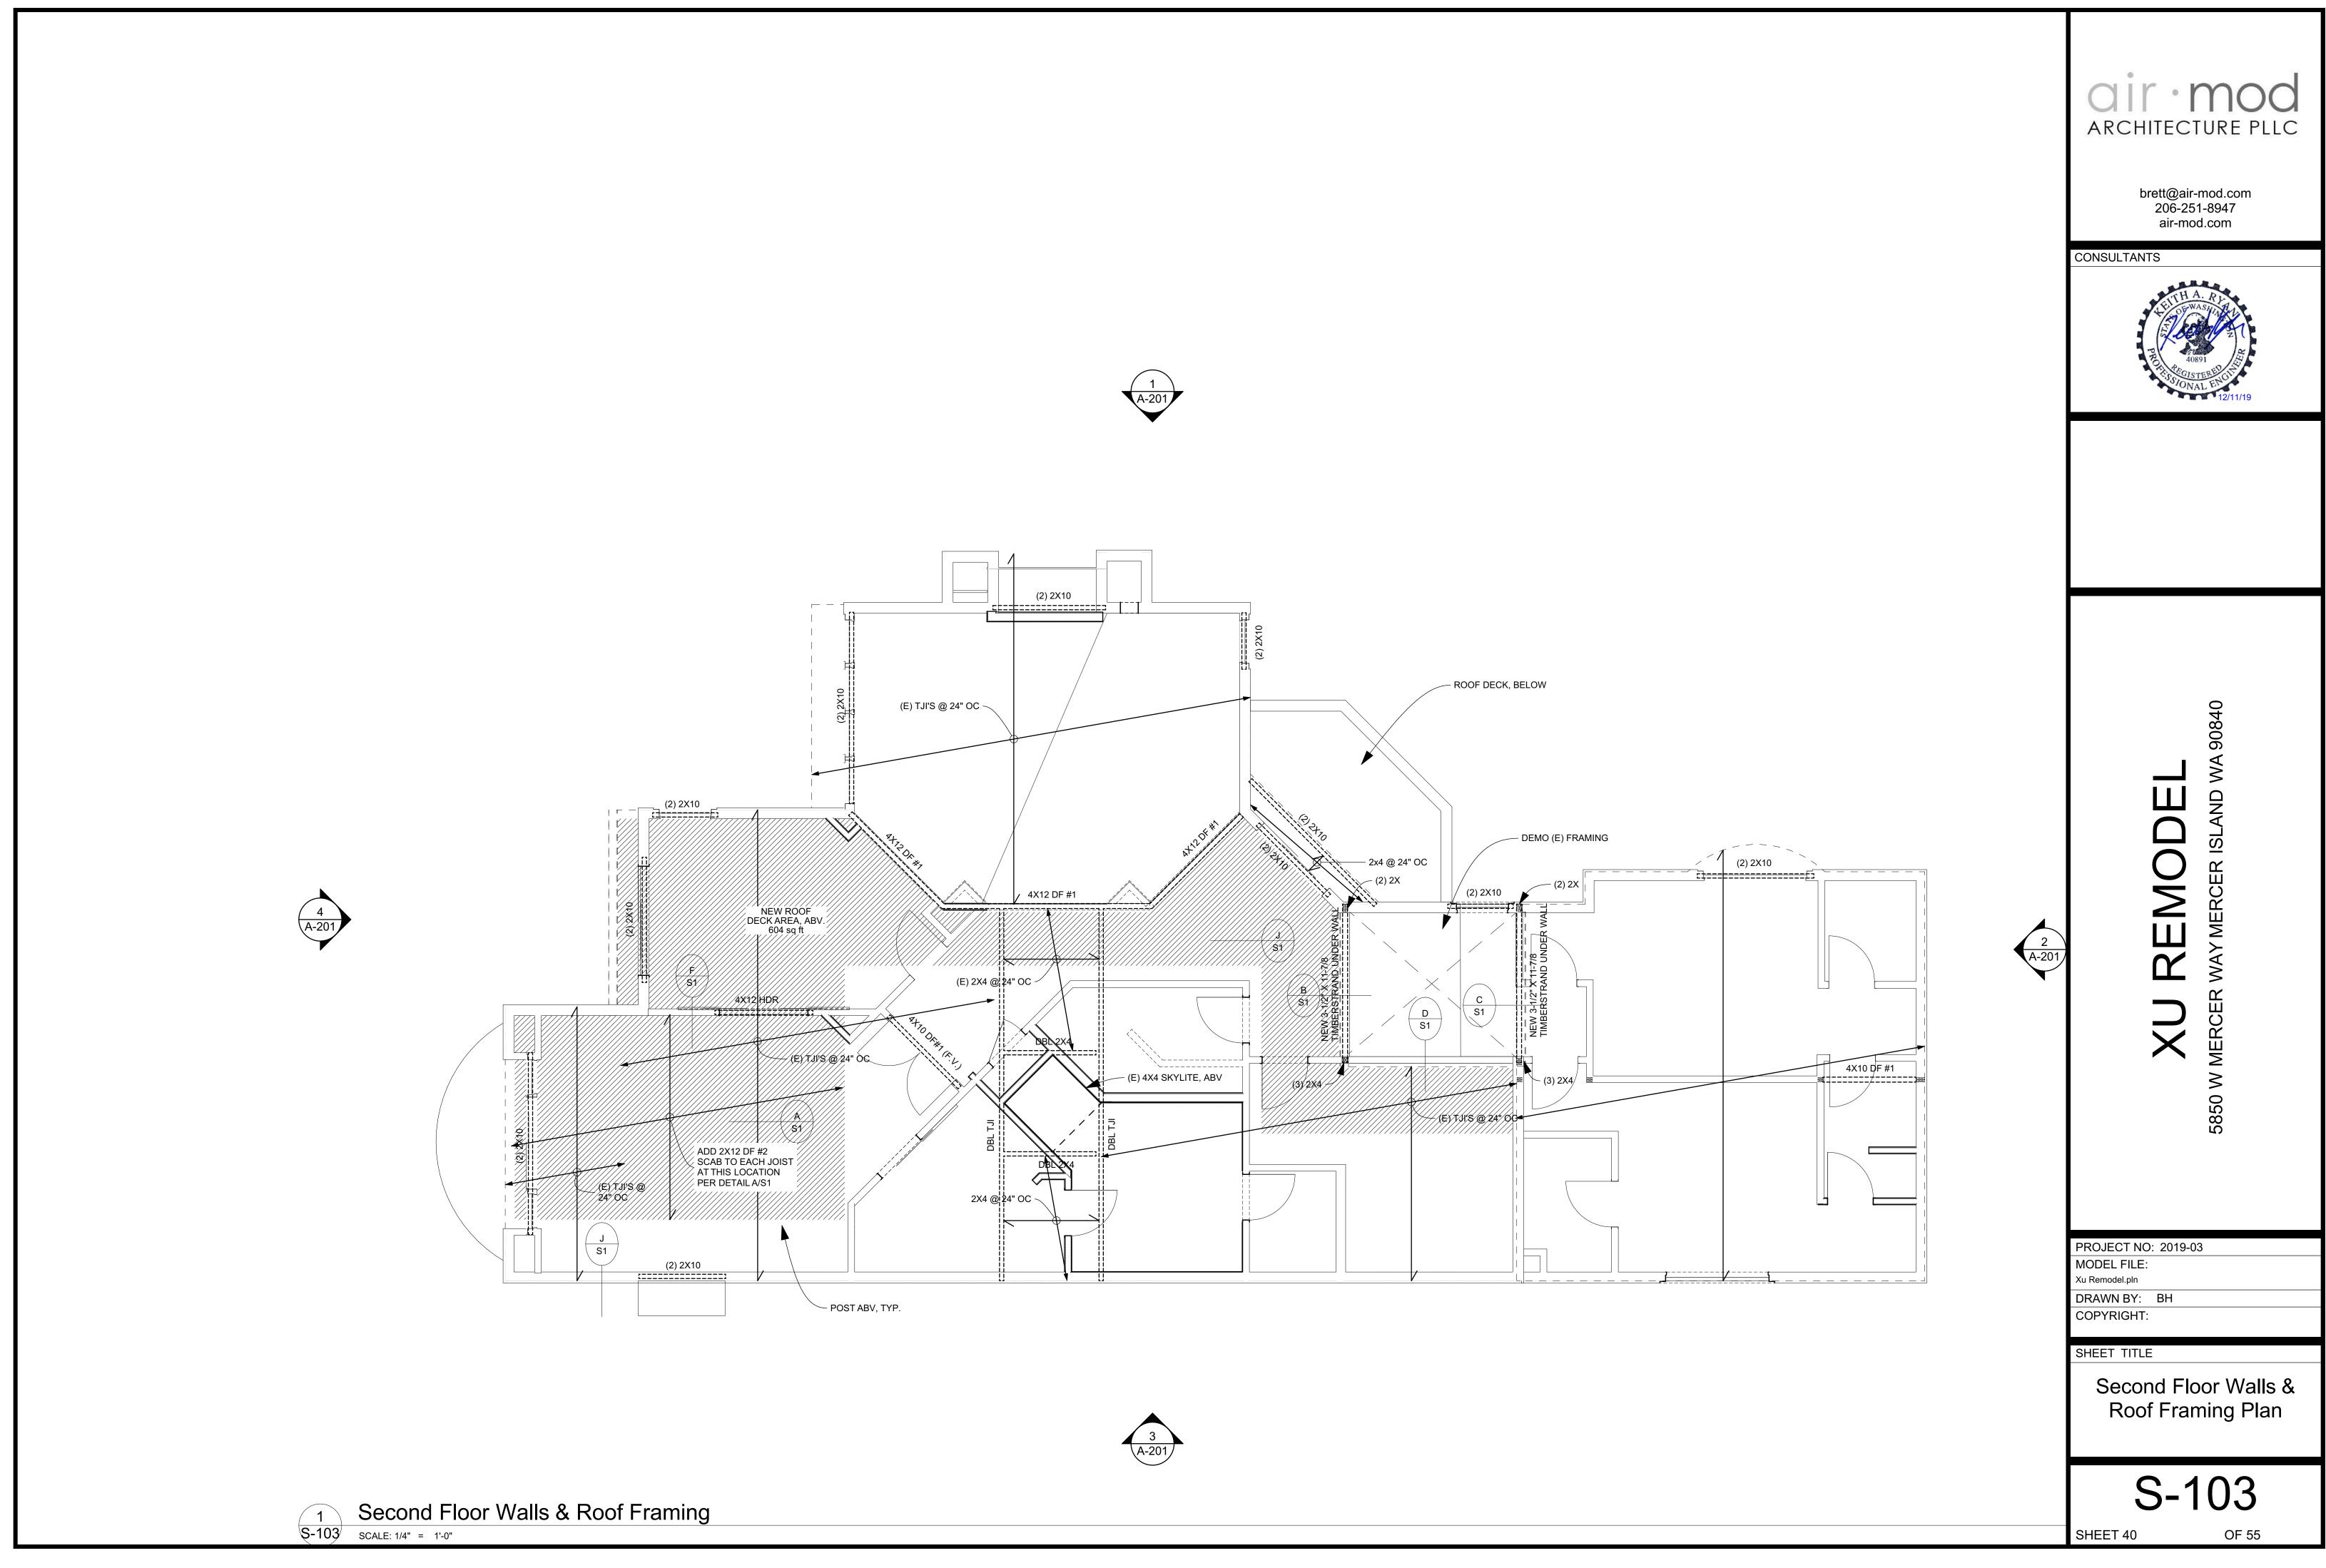
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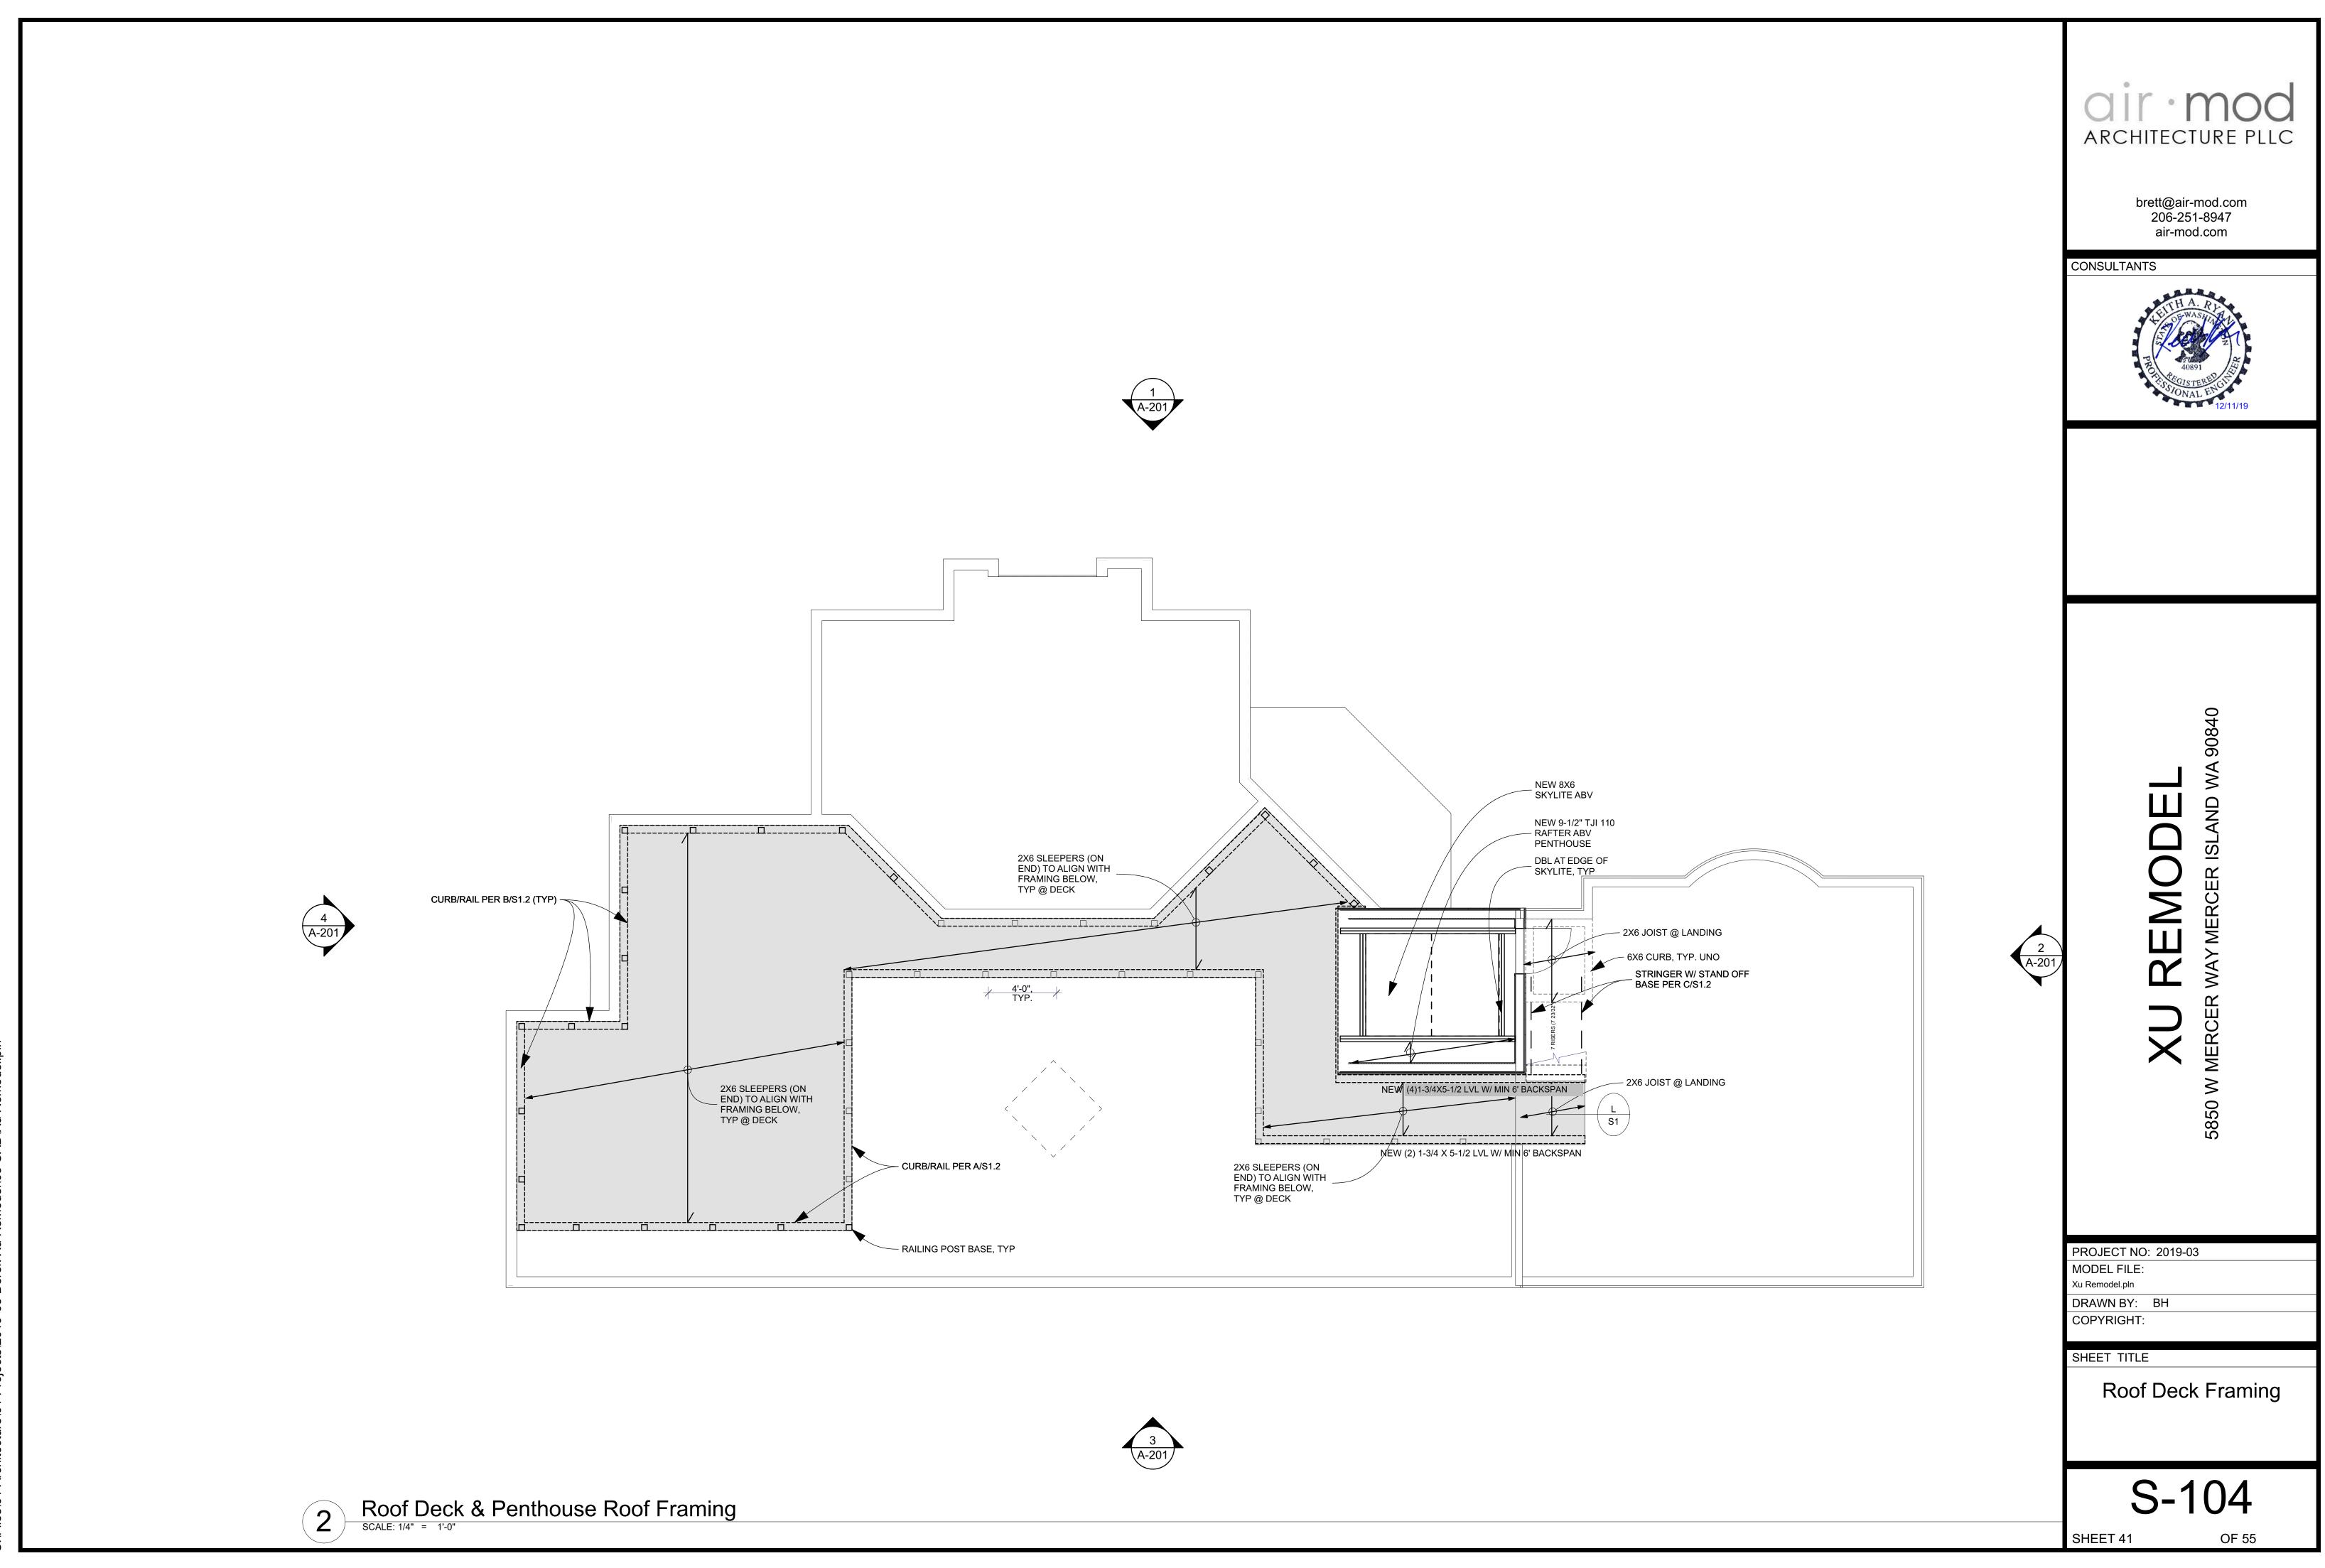




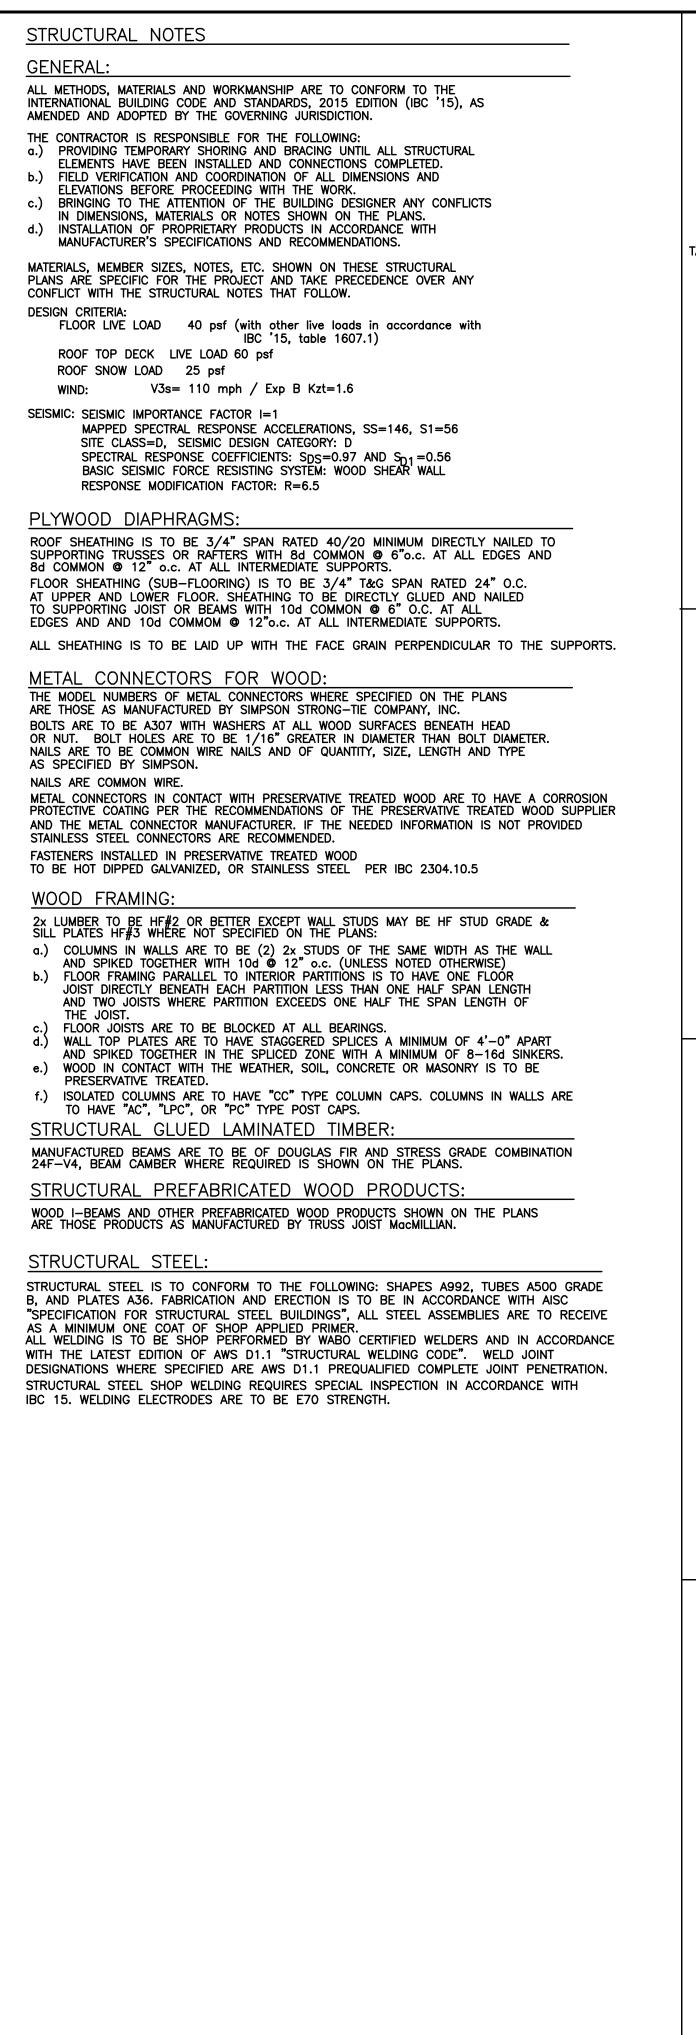
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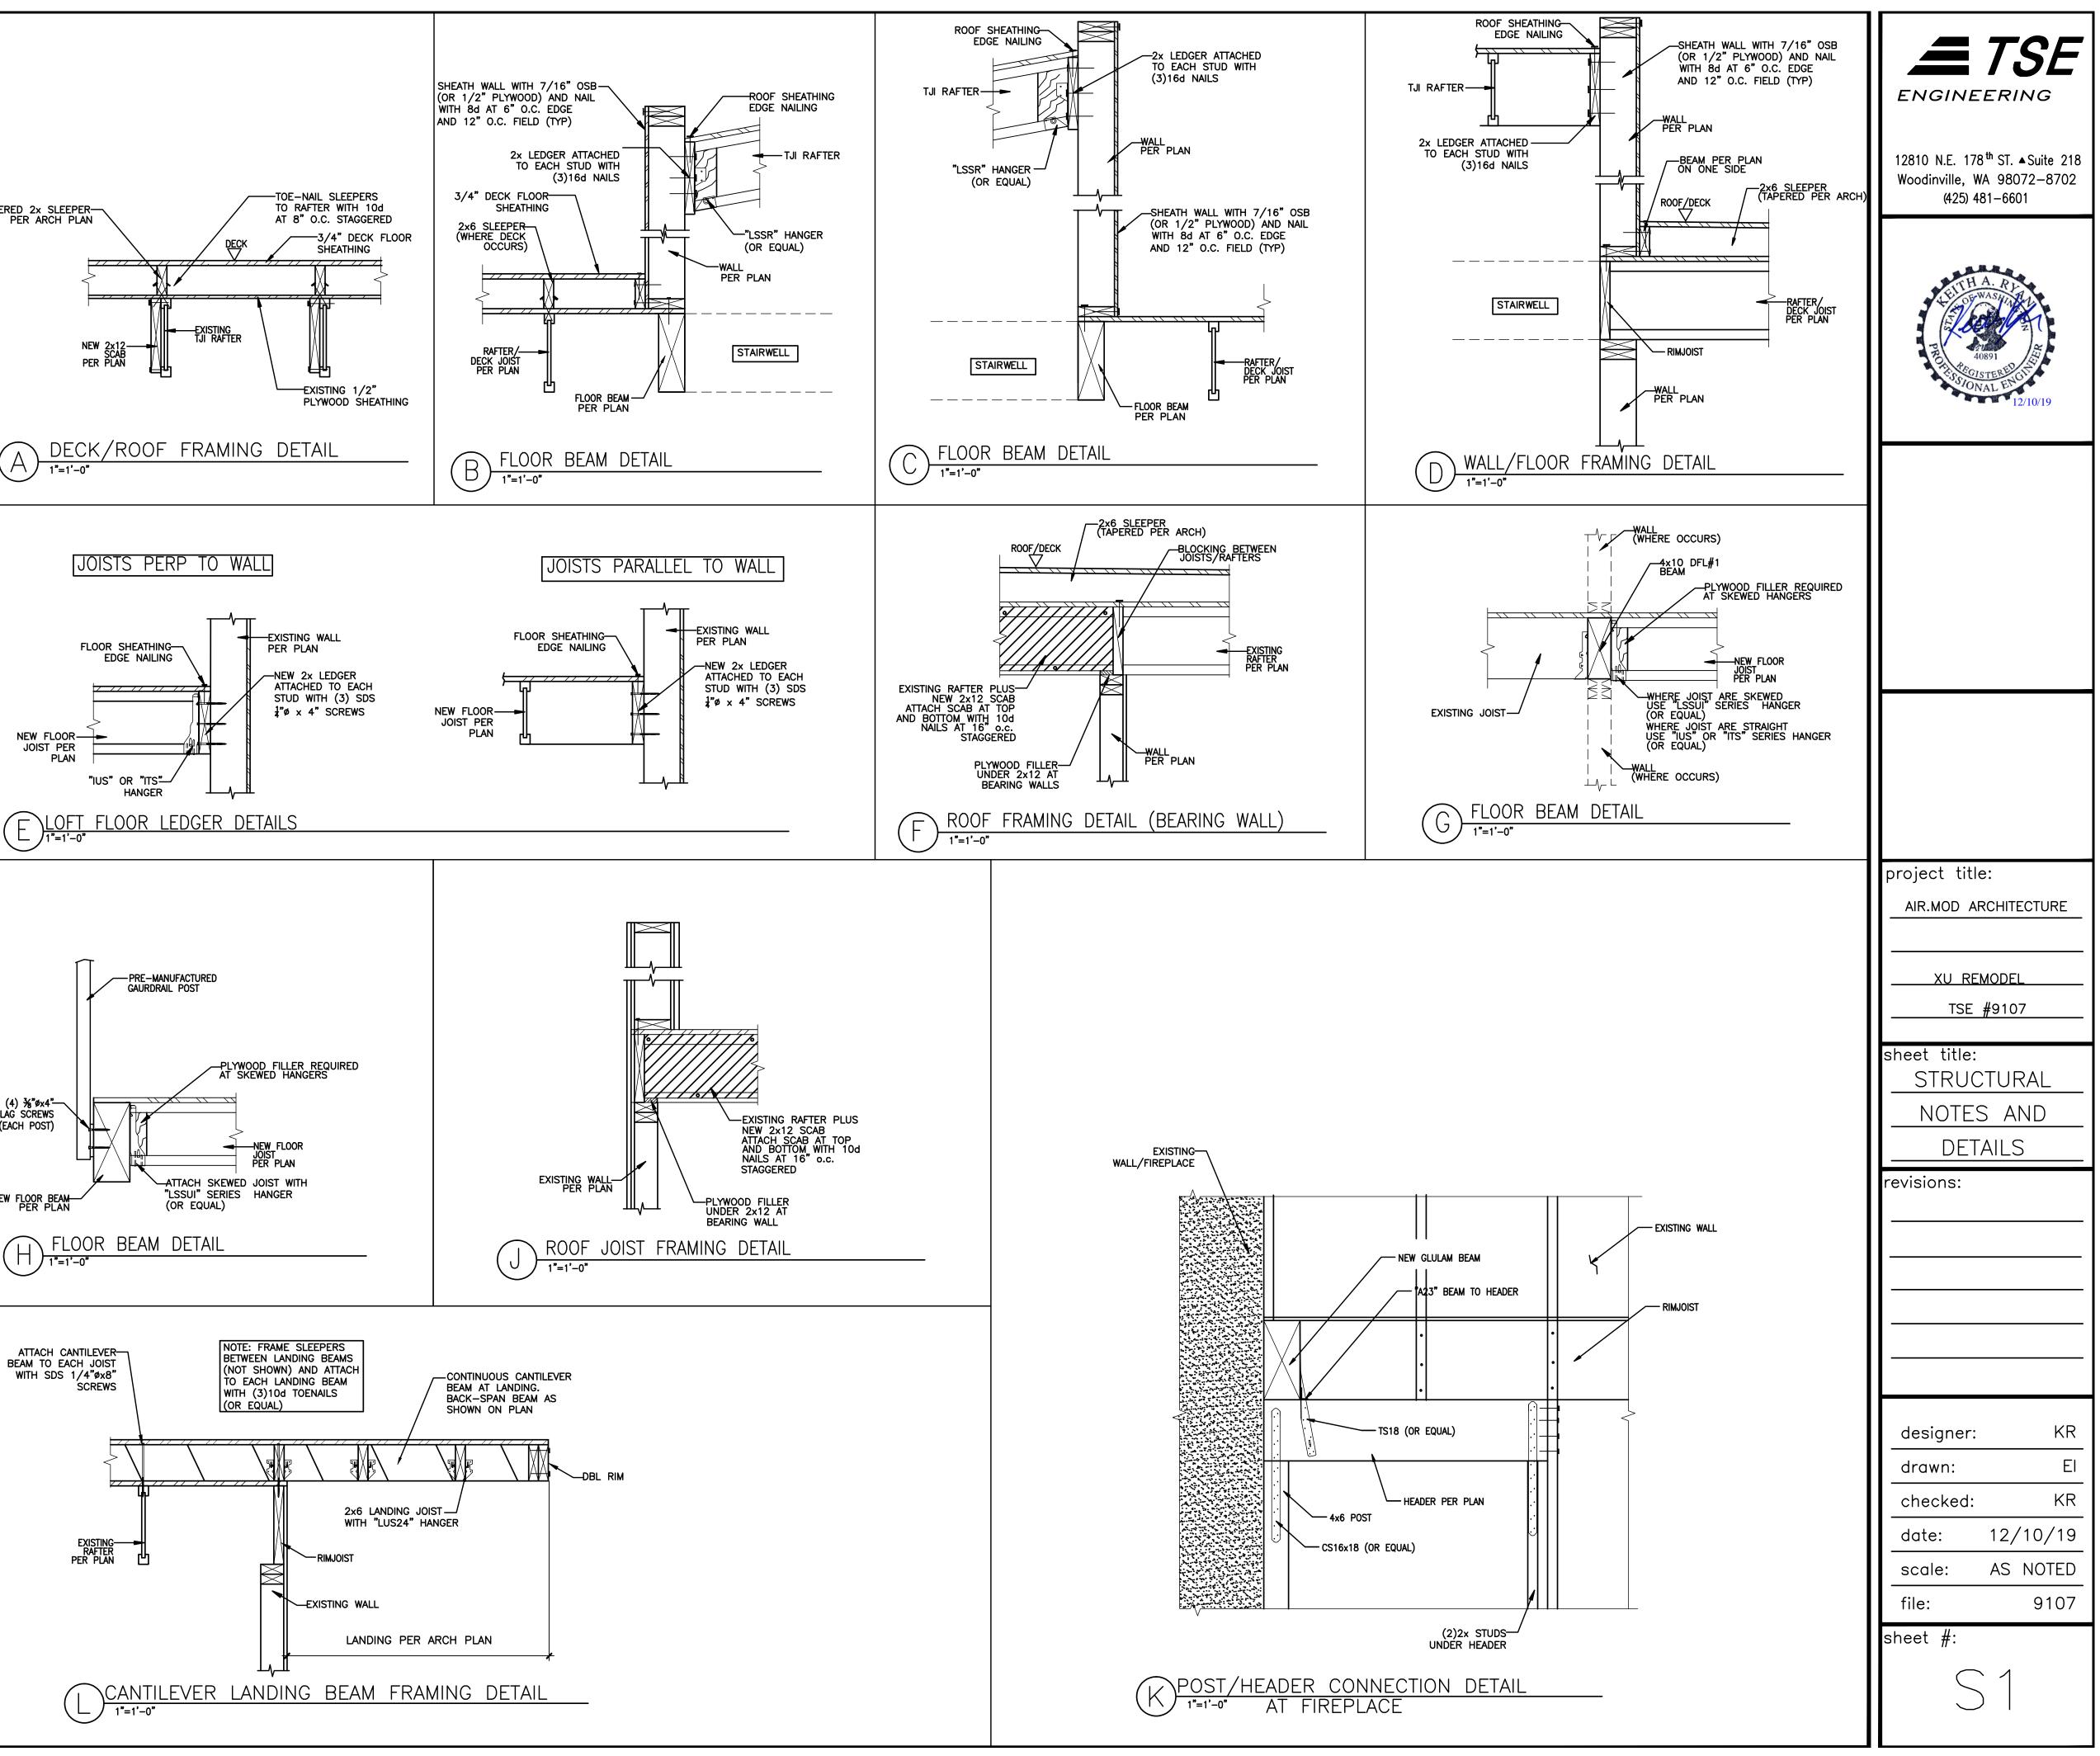


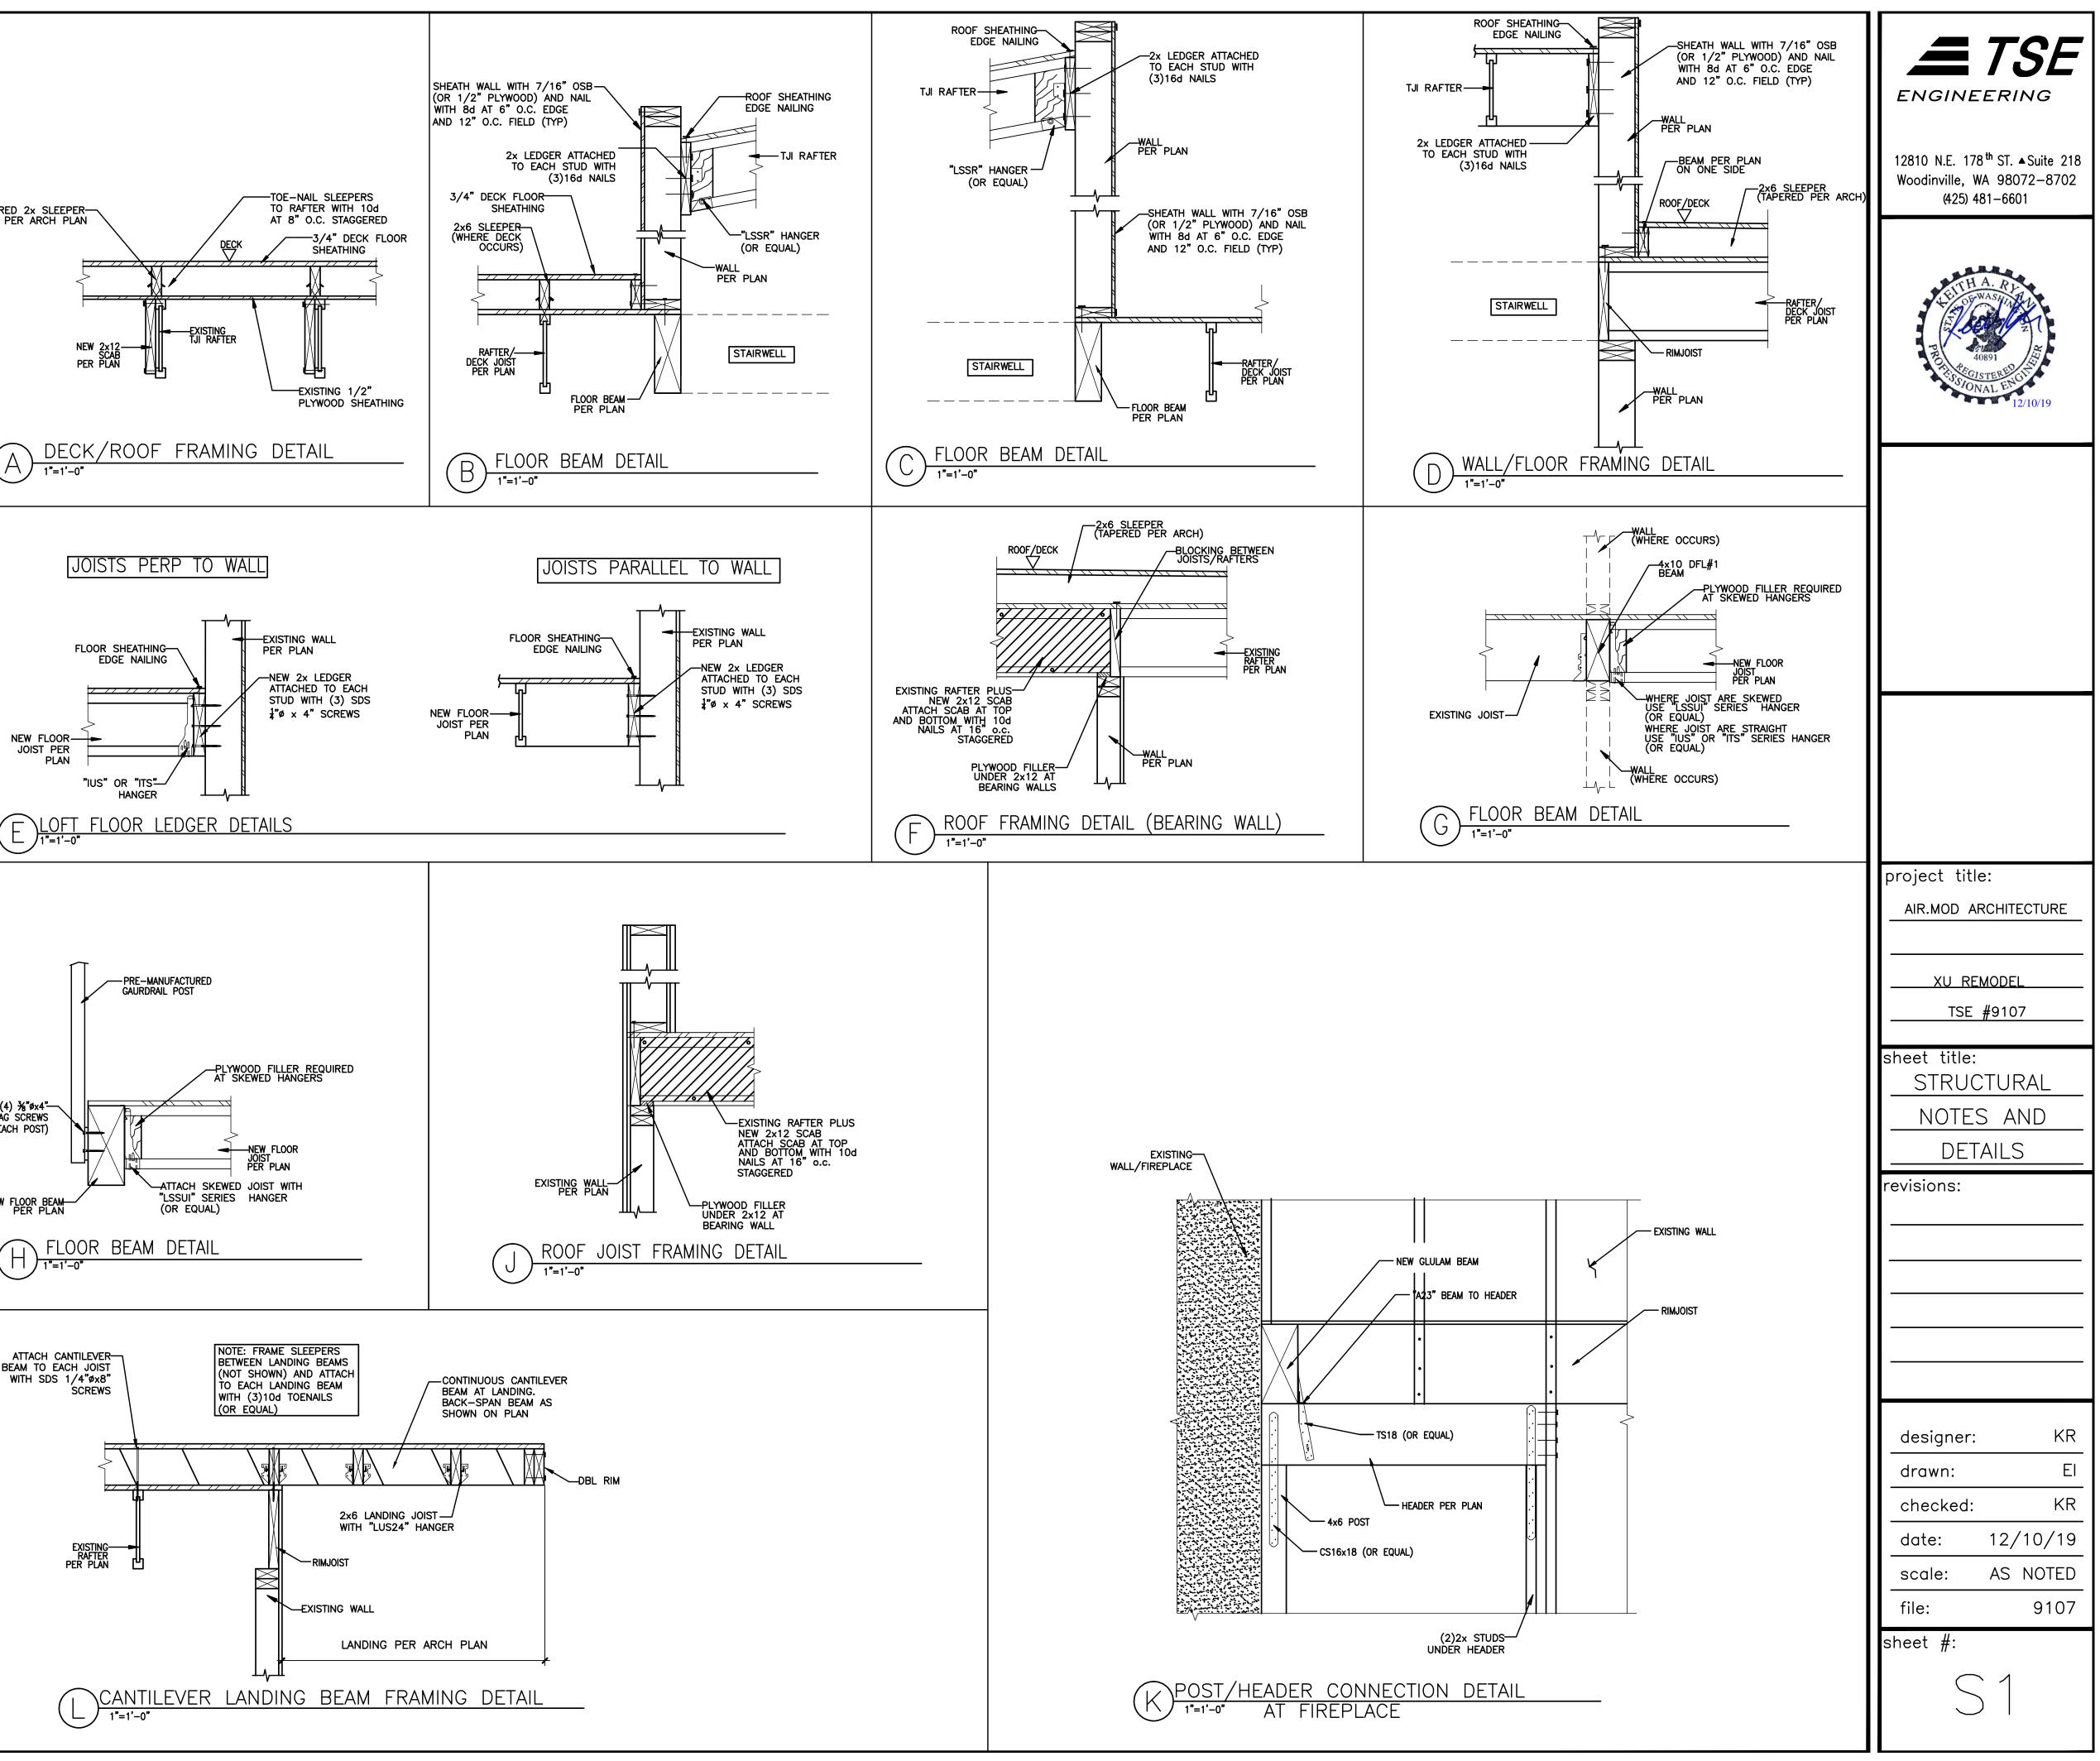


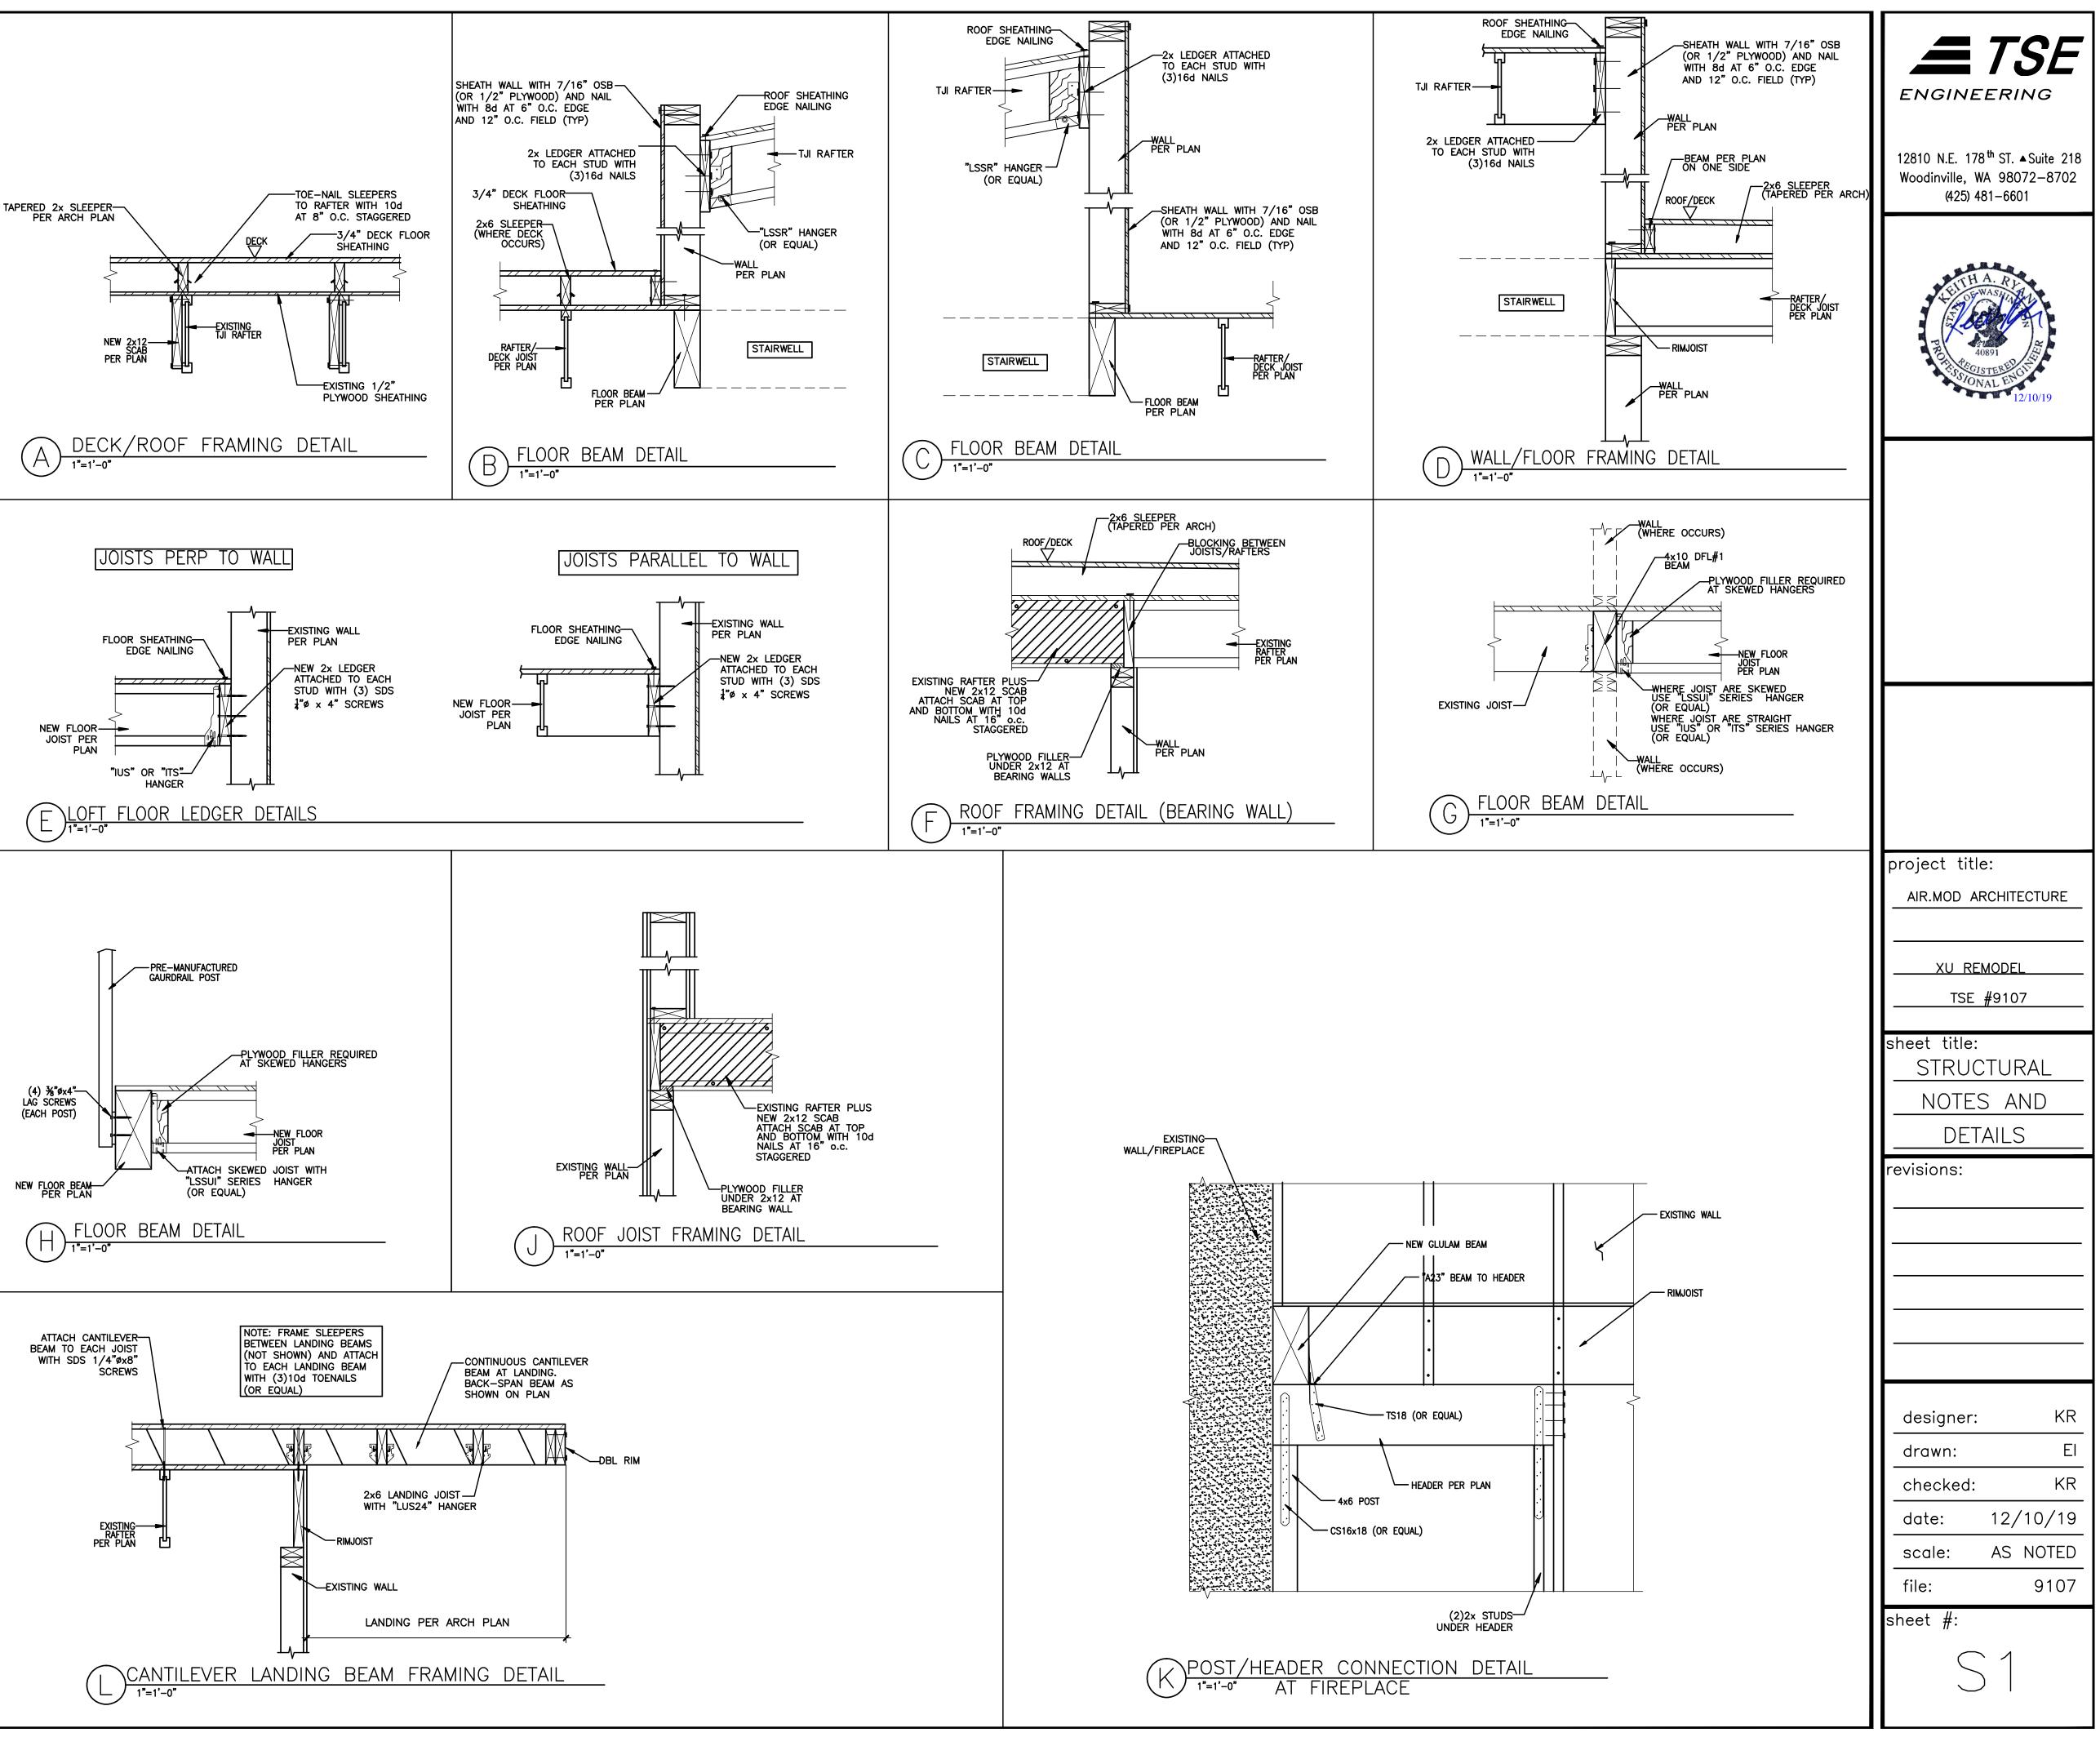


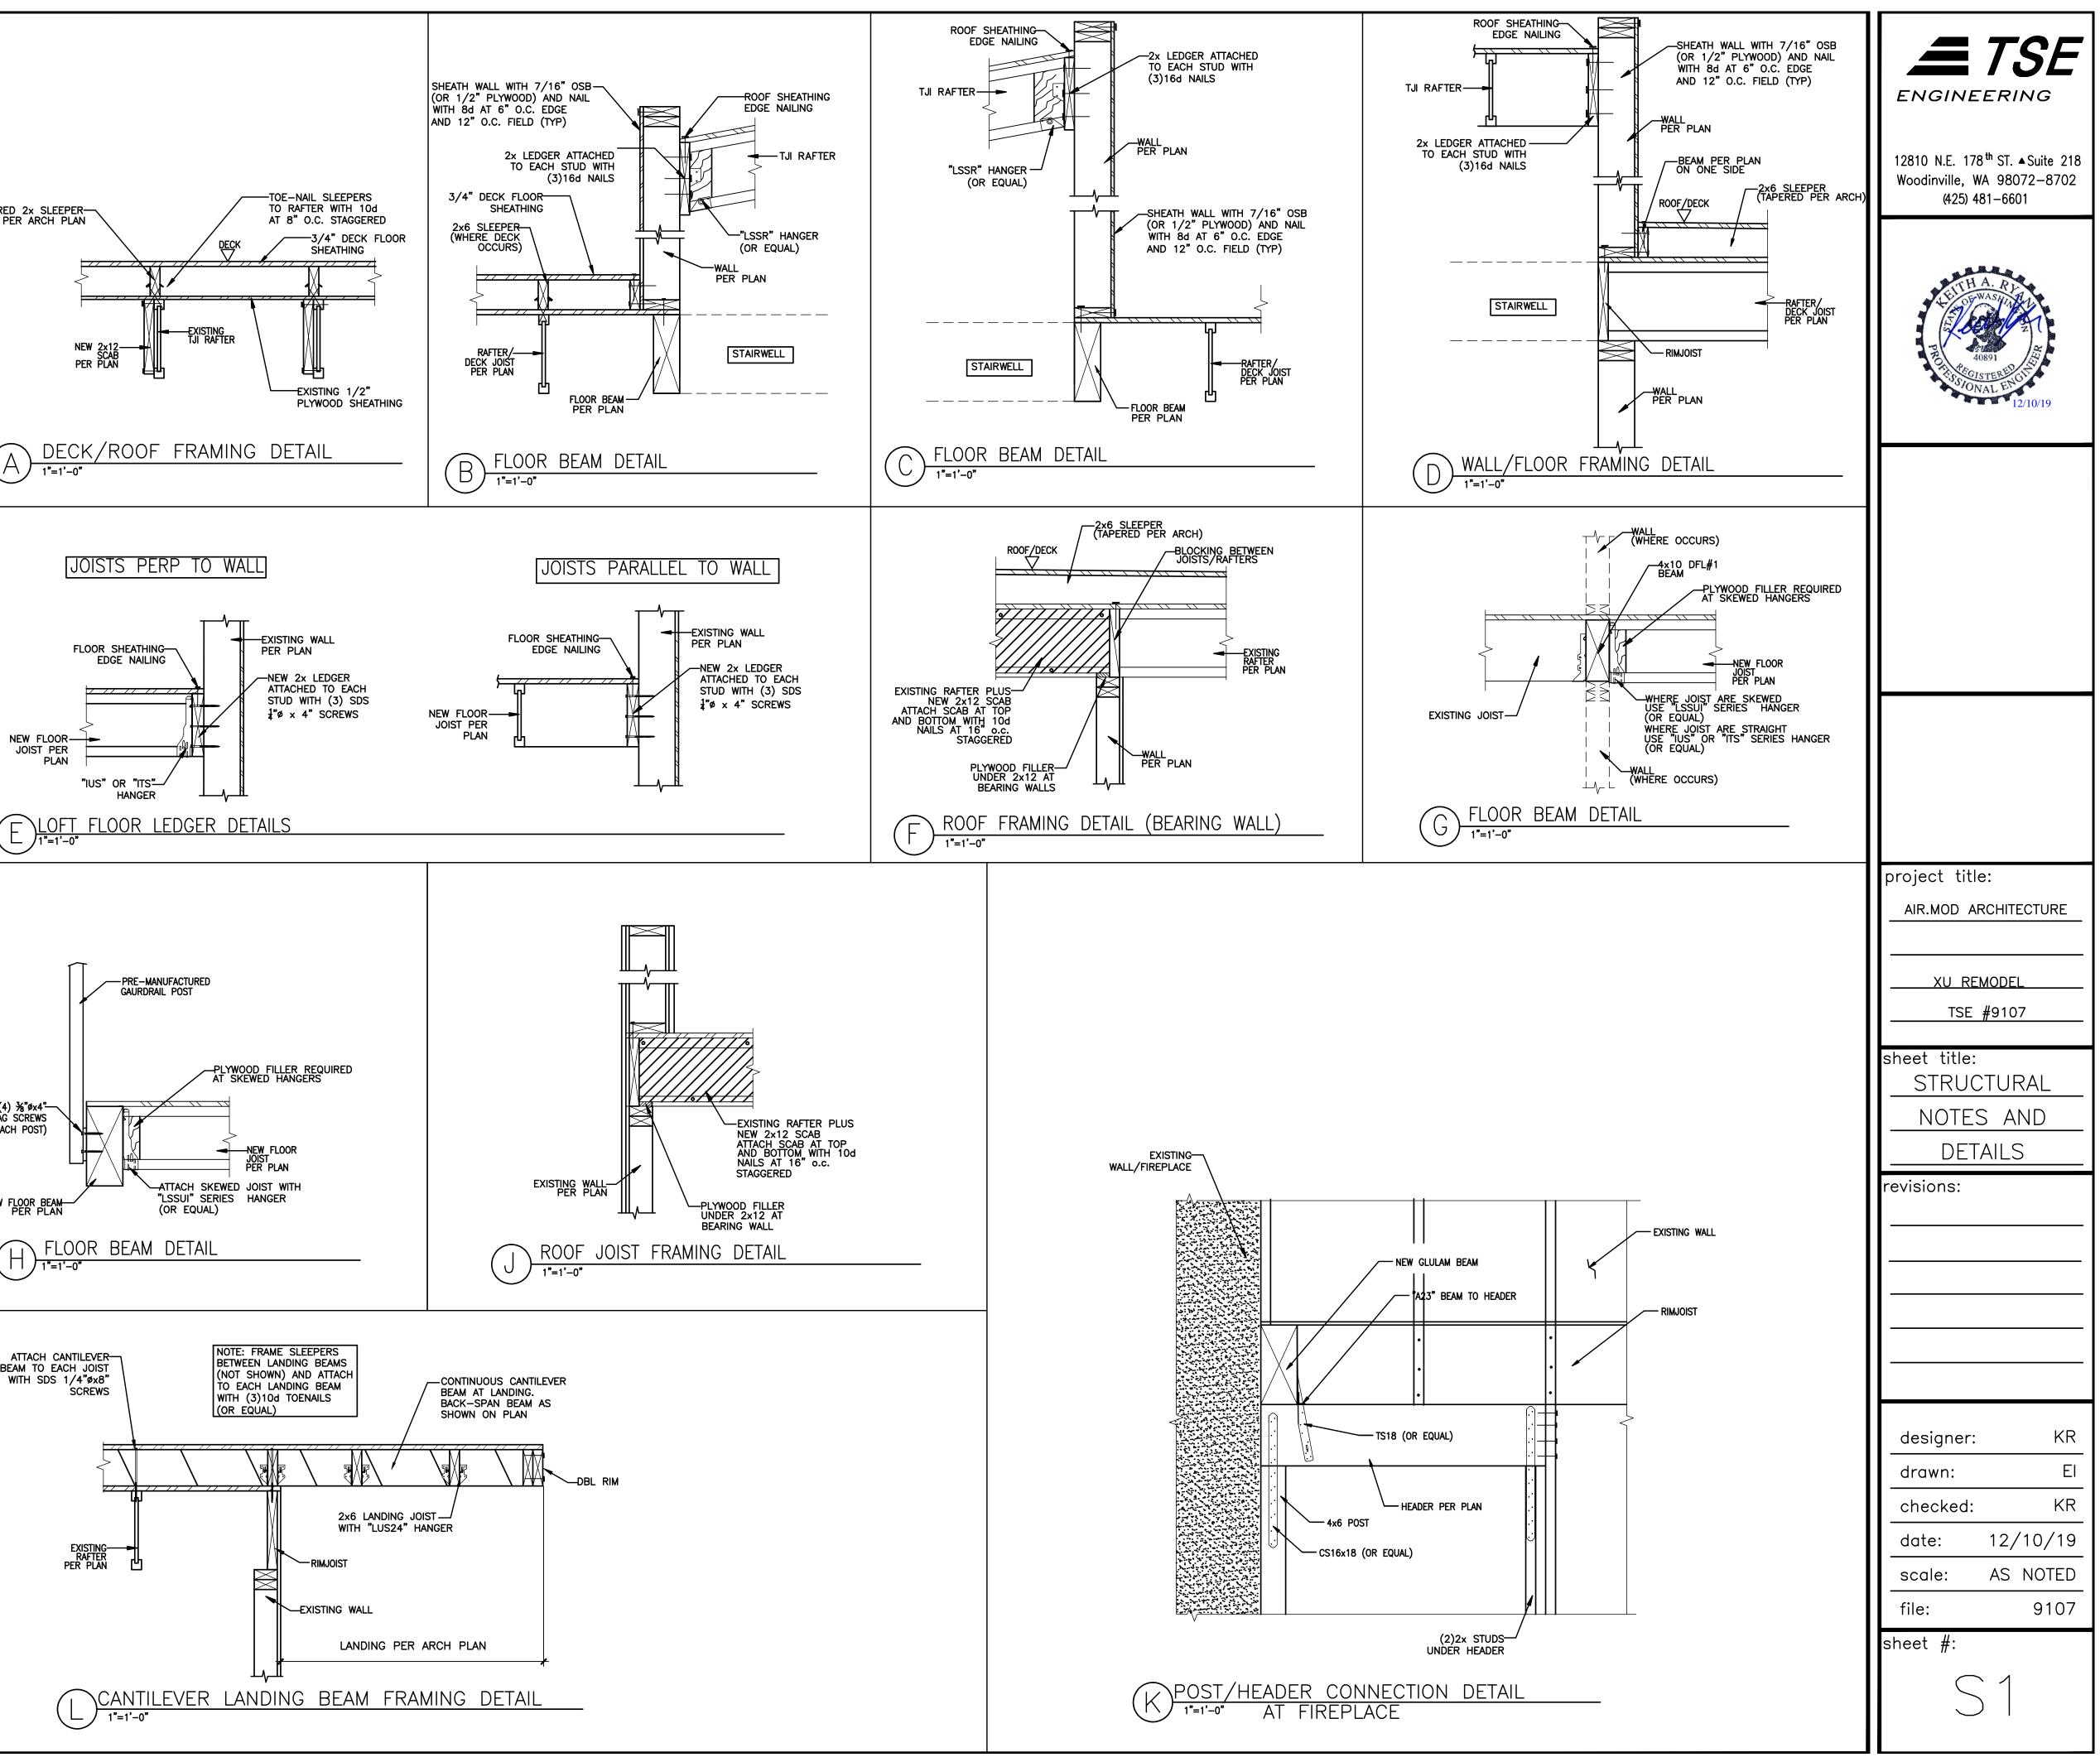
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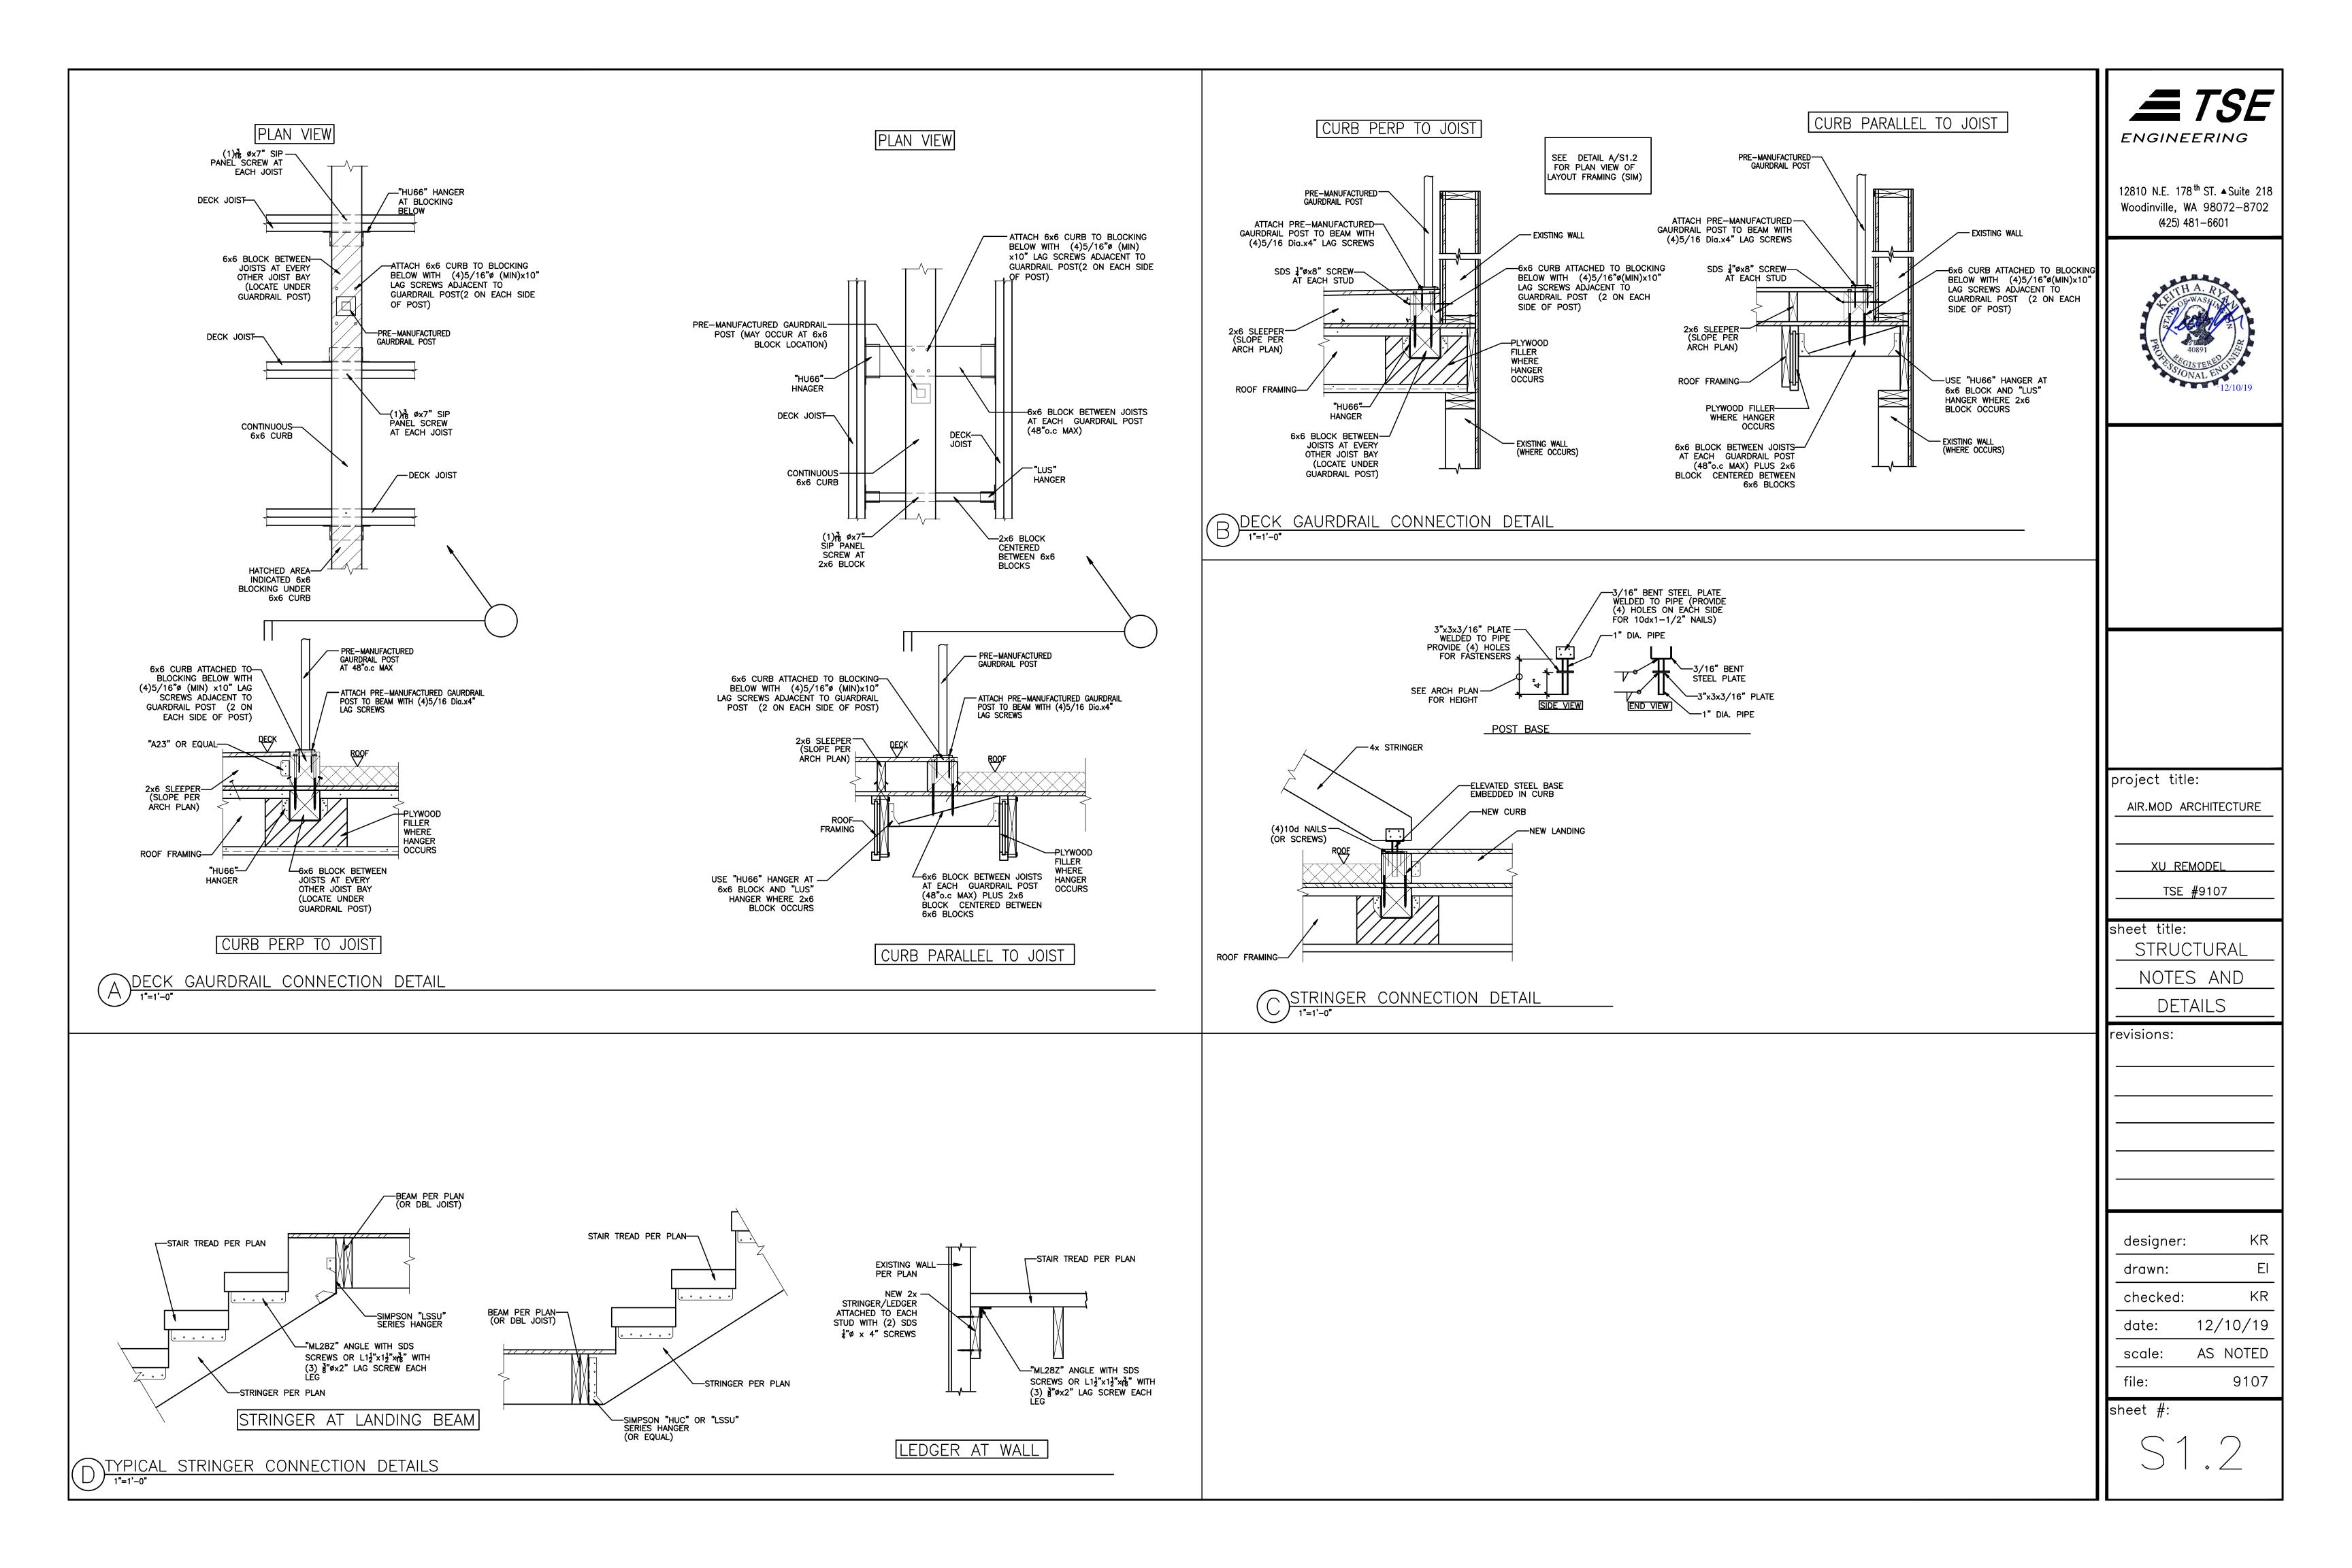


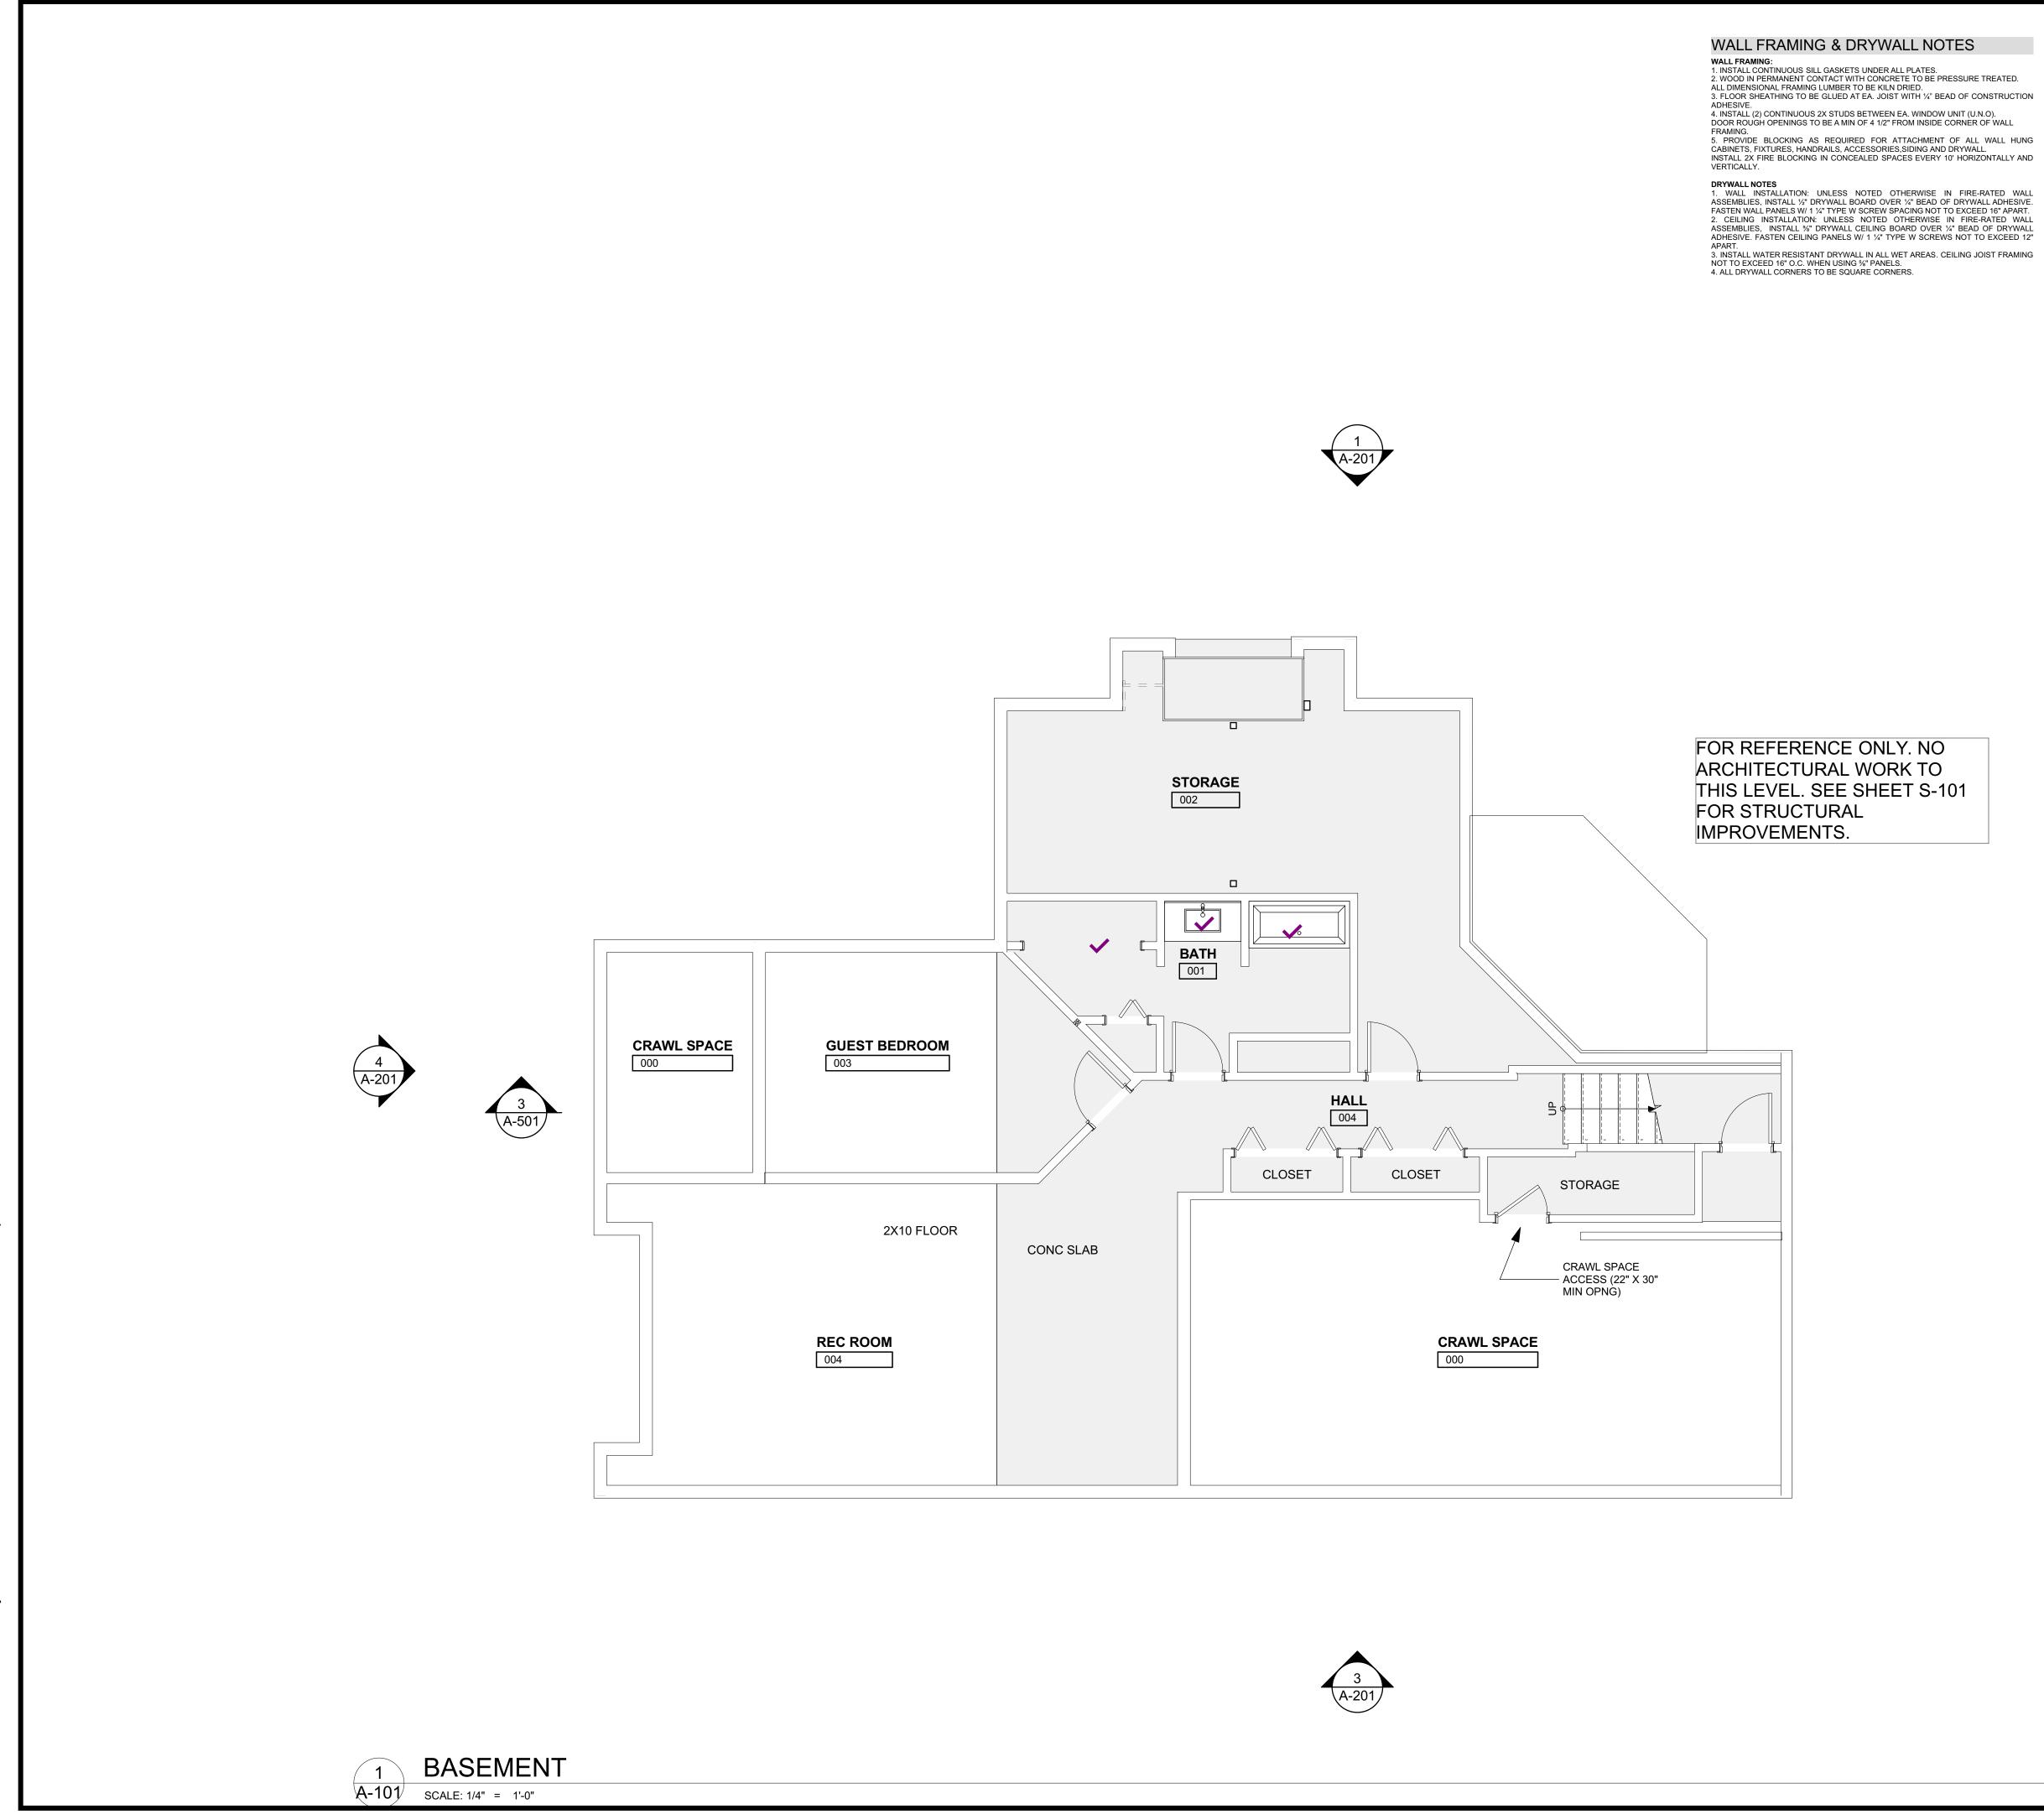












PLAN NOTES

WORKMANSHIP:

LIFE & SAFETY

1. WORKMANSHIP SHALL CONFORM TO THE BEST AND HIGHEST STANDARDS OF QUALITY IN EACH TRADE. ALL WORK SHALL BE FIRMLY SECURE AND RELATIVE TO ELEVATIONS AND DIMENSIONS IN THE DRAWINGS: TRUE TO PLUMB, LEVEL, SQUARE AND LINE. 2. ALL MATERIALS SHALL BE INSTALLED IN STRICT ACCORDANCE WITH THE MANUFACTURER'S WRITTEN SPECIFICATIONS OR MATERIAL'S INSTITUTE

STANDARDS. DIMENSIONING: 1. DIMENSIONS SHALL TAKE PRECEDENCE OVER GRAPHIC REPRESENTATION. DO NOT SCALE THE DRAWINGS. 2. DOORS AND WINDOWS ARE DIMENSIONED TO THE CENTER OF ROUGH OPENINGS. 3. ALL DIMENSIONS ARE GIVEN FROM FACE OF FRAMING UNLESS NOTED OTHERWISE. FOUNDATION PLANS ARE DIMENSIONED FROM FACE OF CONCRETE. 4. SHOULD DIMENSIONAL DISCREPANCIES OCCUR, THE CONTRACTOR SHALL

CONSULT THE DESIGNER BEFORE PROCEEDING WITH WORK. 5. CONTRACTOR TO PROVIDE DESIGNER MANUFACTURER SHOP DRAWINGS & SUBMITTALS FOR ALL CUSTOM FABRICATED ITEMS PRIOR TO ORDERING OR SUBMITTALS FOR ALL CUSTOM FABRICATED TIEMS PRIOR TO ORDERING OR FABRICATION OF ITEMS. THE CONTRACTOR SHALL VERIFY ALL DIMENSIONS IN THE FIELD BEFORE SHOP DRAWINGS ARE MADE AND BEFORE ANY WORK IS CONSTRUCTED OR FABRICATED. 6. INTERIOR FLOOR AREA IS MEASURED TO THE EXTERIOR FACE OF FRAMING. THE STAIRWAY IS COUNTED AS SQUARE FOOTAGE ON ALL FLOORS. 7. ACCESSORY DWELLING FLOOR AREAS ARE MEASURED TO THE INTERIOR FACE OF WALL INTERS.

WALL UNLESS NOTED OTHERWISE. 8. SITE AREAS PERTAINING TO LOT COVERAGE OR DRAINAGE ARE TO BE MEASURED ACCORDING TO THE REQUIREMENTS OF THE JURISDICTION. 9. VERIFY ROUGH OPENING AND CLEARANCE REQUIREMENTS OF ALL FIXTURES PRIOR TO COMMENCING WITH FRAMING. PLAN REVIEW/INSPECTOR CHANGES:

1. THE DESIGNER SHALL NOT BE HELD RESPONSIBLE FOR CHANGES REQUESTED BY PLAN REVIEWERS AND/OR FIELD INSPECTORS OF THE GOVERNMENTAL AUTHORITIES HAVING JURISDICTION OVER THIS WORK. 2. SHOULD AN AUTHORITY FIND A CONFLICT WITH CODE OR REGULATIONS, THE CONTRACTOR SHALL CONSULT THE DESIGNER BEFORE PROCEEDING WITH WORK.

1. PER NFPA 72 & SECTION R314 COMBINATION SMOKE AND CARBON MONOXIDE ALARMS TO BE INSTALLED, ALL DEVICES SHALL BE INTERCONNECTED IN SUCH A MANNER THAT THE ACTUATION OF ONE ALARM WILL ACTIVATE ALL ALARMS. DETECTORS SHALL BE CONNECTED TO THE BUILDING'S POWER SUPPLY. IN THE EVENT BUILDING POWER IS INTERRUPTED DETECTOR SHALL RECEIVE POWER FROM A BATTERY BACKUP. 2. COMBINATION SMOKE ALARM & CARBON MONOXIDE ALARM TO BE INSTALLED IN: EACH SLEEPING ROOM; OUTSIDE SLEEPING AREAS ON ALL FLOORS; CENTRALLY LOCATED ON EVERY FLOOR; IN EACH LOCATION WHERE THERE IS A CEILING HT. CHANGE GREATER THAN 24" 3. ALL EGRESS WINDOW & DOORS TO MEET THE REQUIREMENTS OF SECTION R310 EMERGENCY ESCAPE AND RESCUE OPENINGS. ALL DOOR AND WINDOW GLAZING TO MEET THE SAFETY GLASS / TEMPERING REQUIREMENTS OF SECTION R308. ALL SILL HEIGHTS BELOW 24" TO BE PROTECTED FROM FALL HAZARD.



brett@air-mod.com 206-251-8947 air-mod.com

CONSULTANTS



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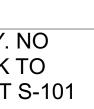
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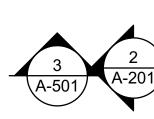
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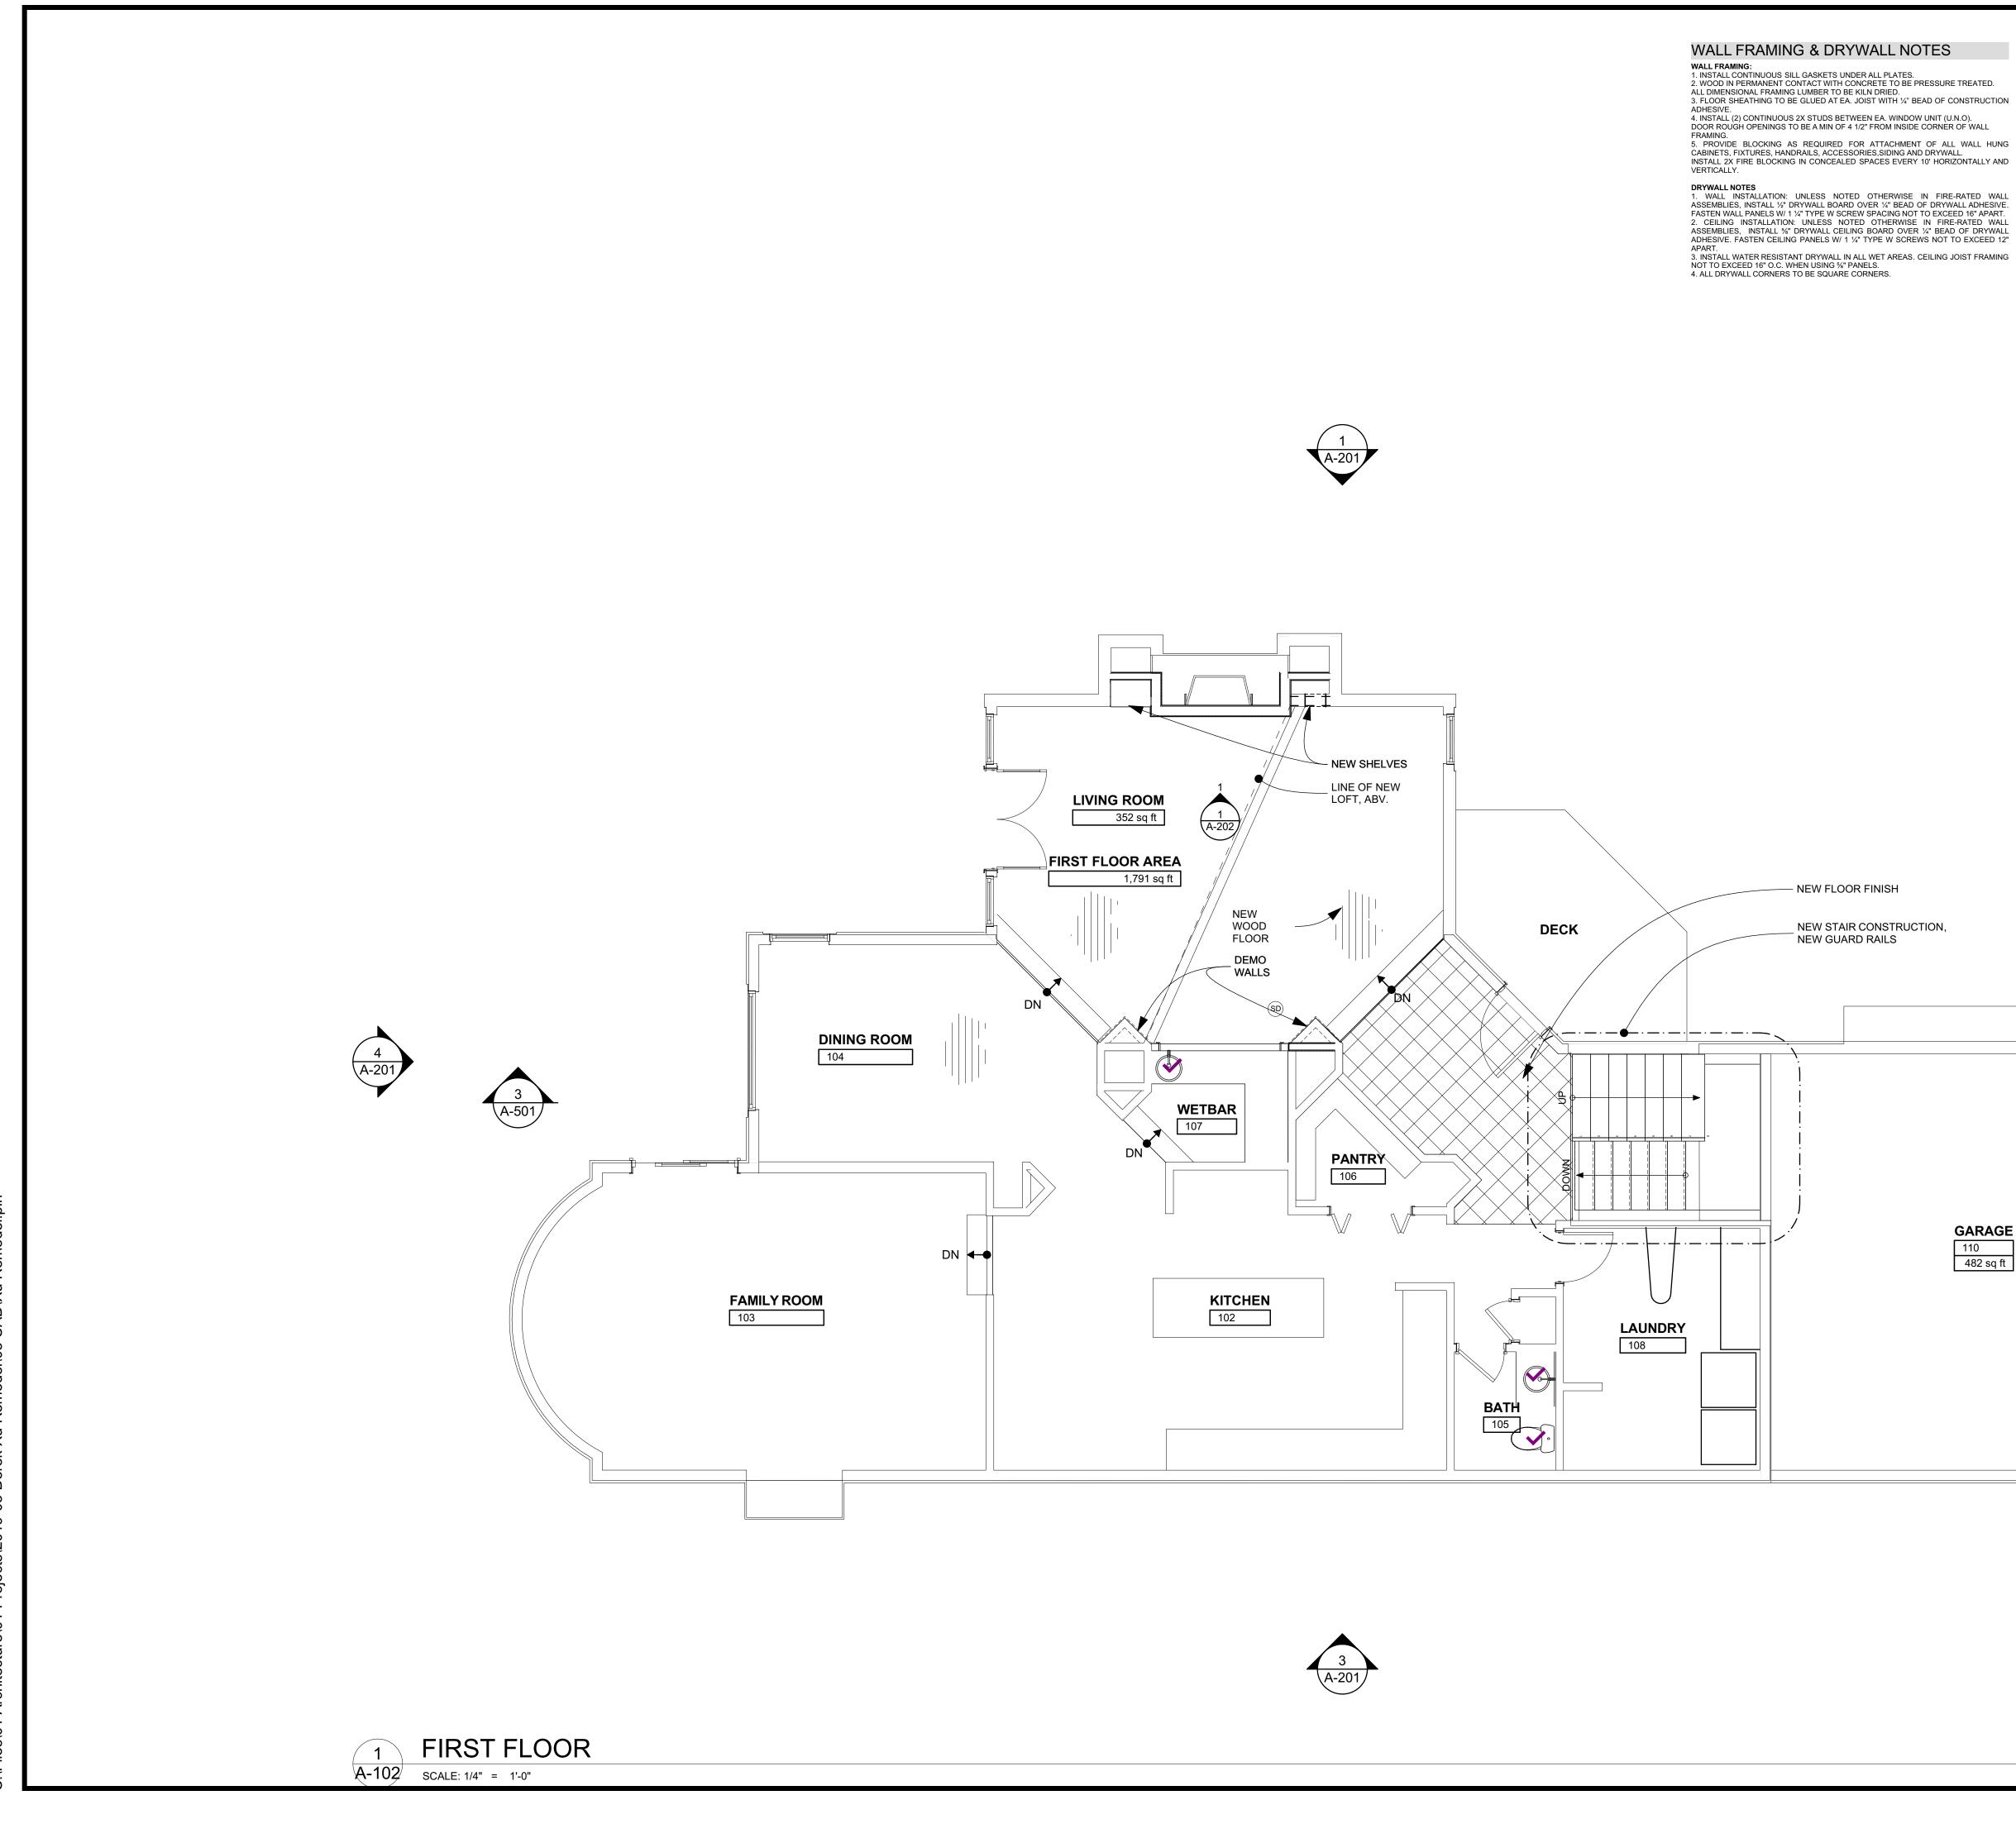
Basement Plan







SHEET 45



WALL FRAMING & DRYWALL NOTES WALL FRAMING: 1. INSTALL CONTINUOUS SILL GASKETS UNDER ALL PLATES. 2. WOOD IN PERMANENT CONTACT WITH CONCRETE TO BE PRESSURE TREATED. ALL DIMENSIONAL FRAMING LUMBER TO BE KILN DRIED. 3. FLOOR SHEATHING TO BE GLUED AT EA. JOIST WITH 1/4" BEAD OF CONSTRUCTION 4. INSTALL (2) CONTINUOUS 2X STUDS BETWEEN EA. WINDOW UNIT (U.N.O). DOOR ROUGH OPENINGS TO BE A MIN OF 4 1/2" FROM INSIDE CORNER OF WALL 5. PROVIDE BLOCKING AS REQUIRED FOR ATTACHMENT OF ALL WALL HUNG CABINETS, FIXTURES, HANDRAILS, ACCESSORIES, SIDING AND DRYWALL. INSTALL 2X FIRE BLOCKING IN CONCEALED SPACES EVERY 10' HORIZONTALLY AND

PLAN NOTES

WORKMANSHIP:

STANDARDS.

LIFE & SAFETY

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WAY MERCER ISLAI

5850 W MERCER

First Floor Plan

A-102

SHEET 46

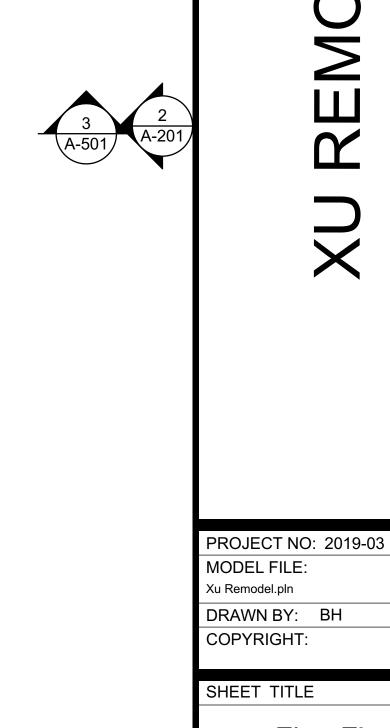
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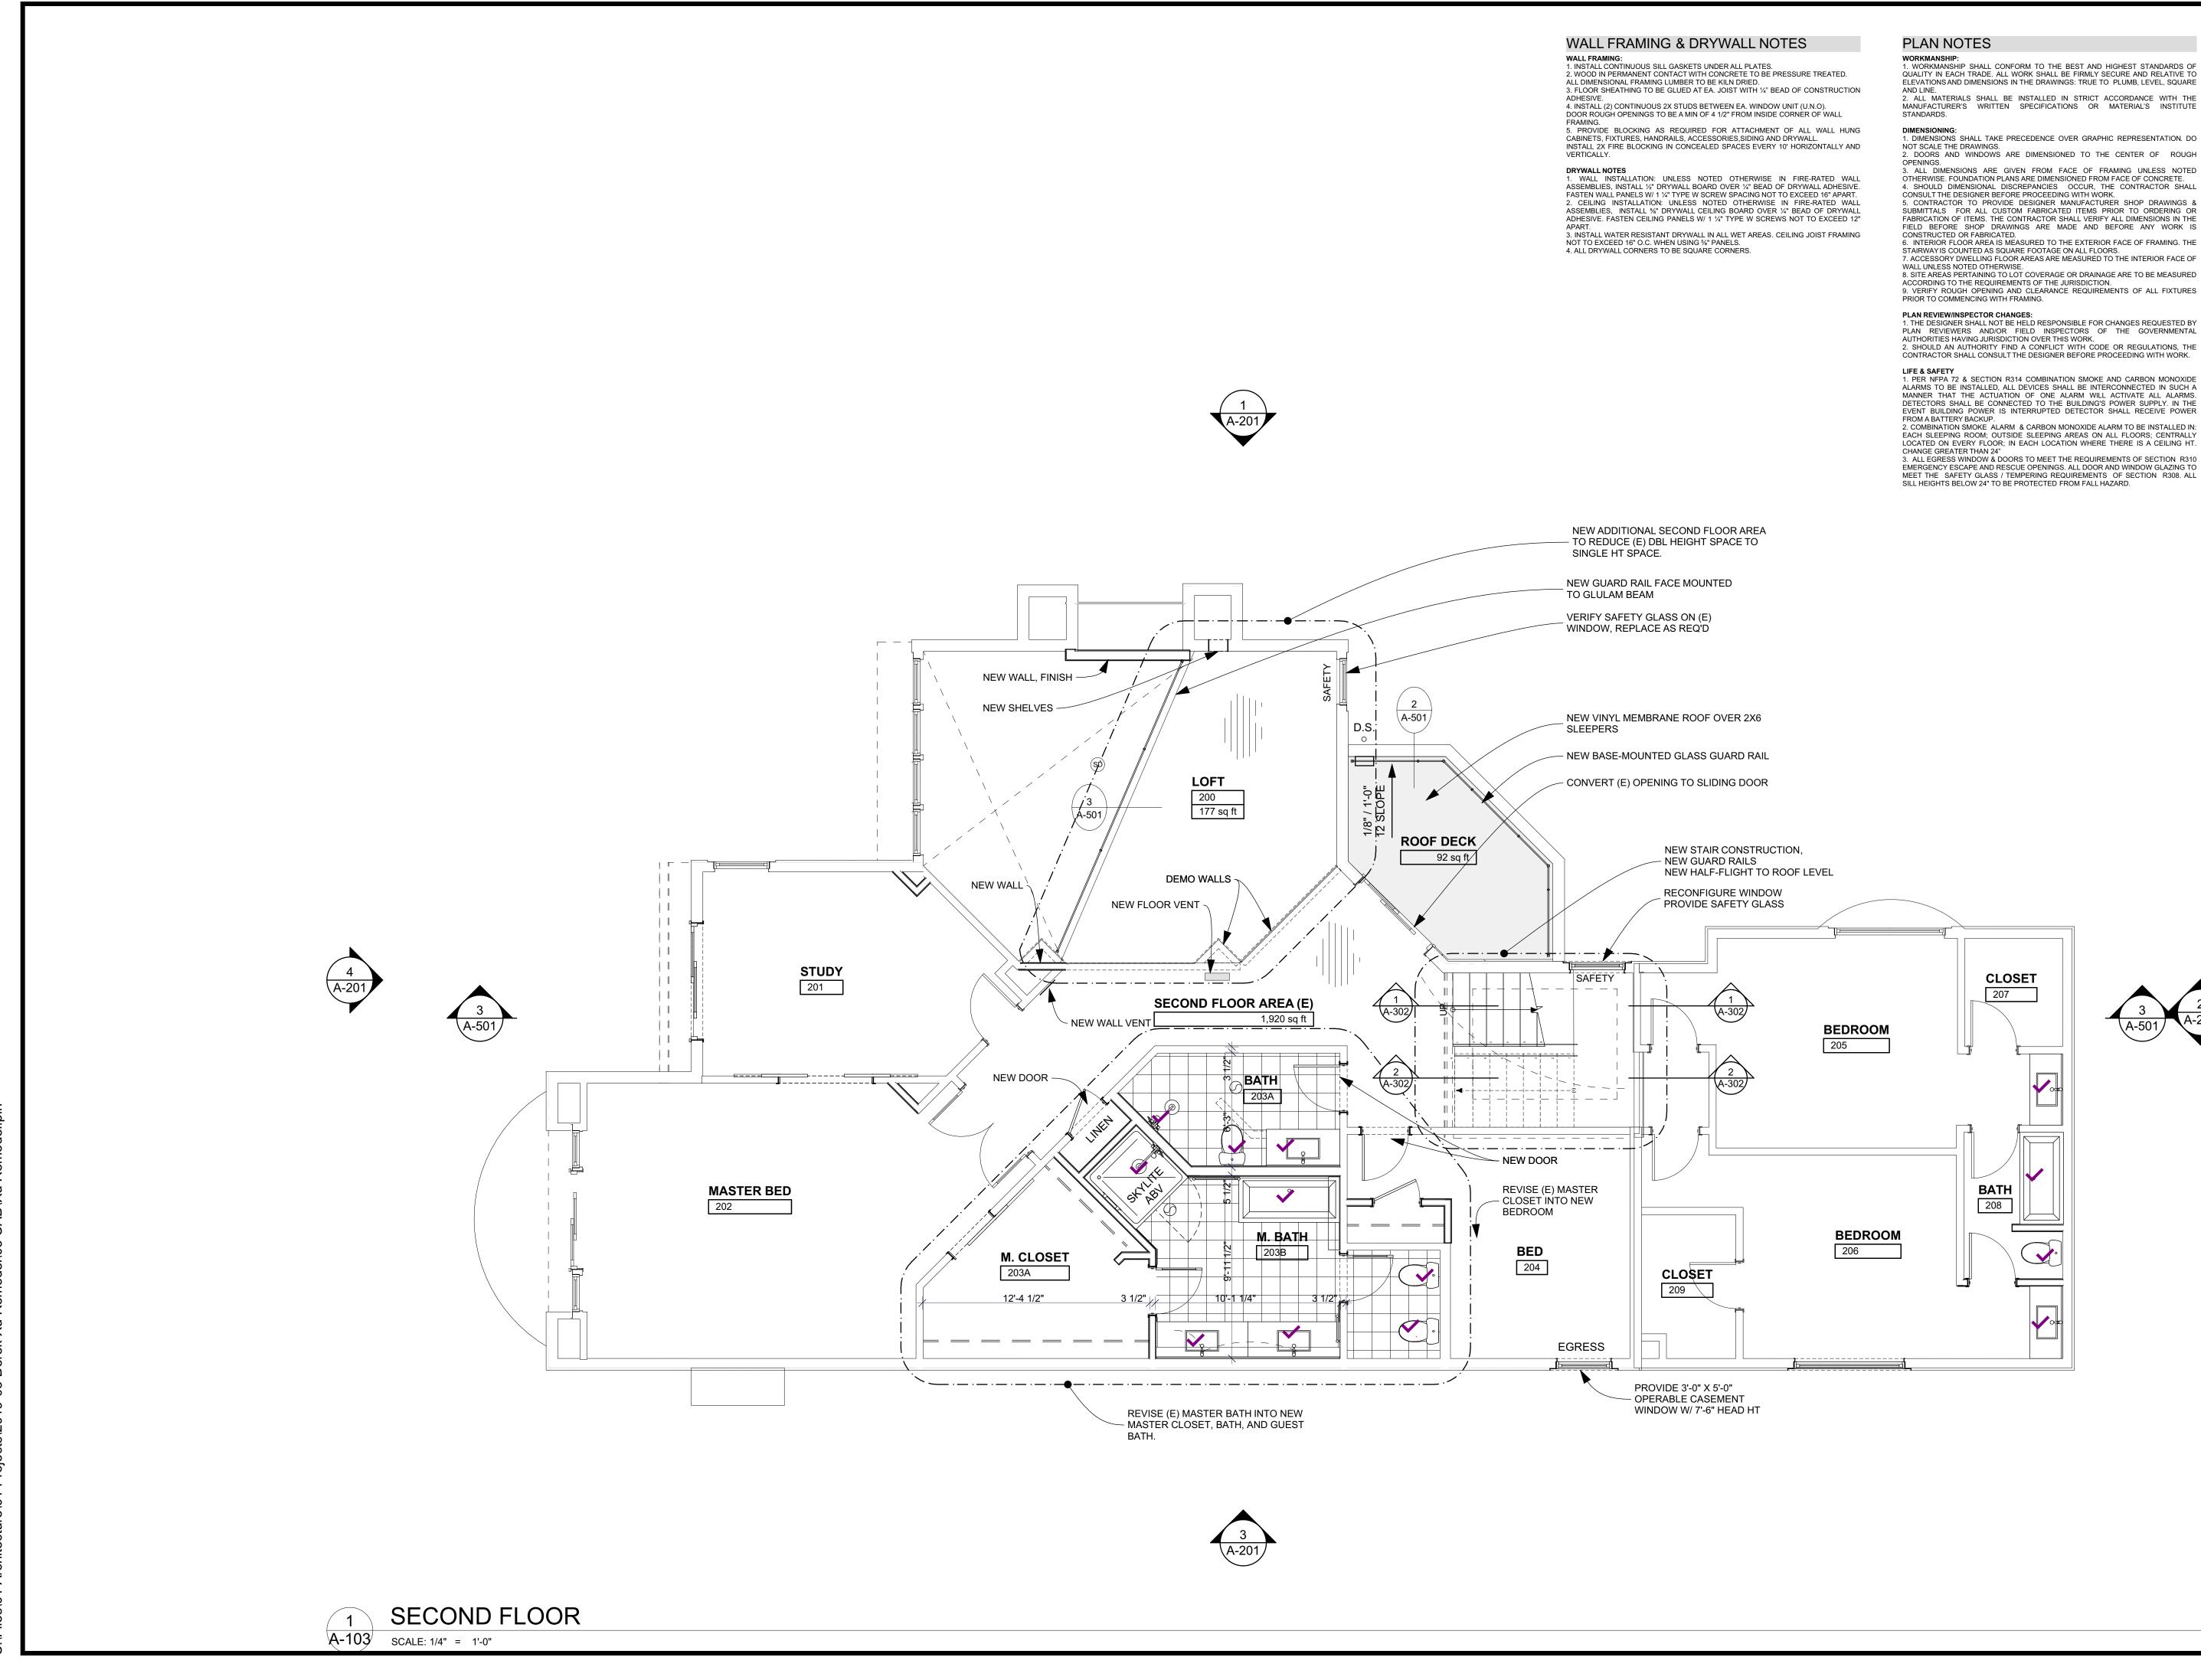
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REMOD

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GARAGE 110 482 sq ft





QUALITY IN EACH TRADE. ALL WORK SHALL BE FIRMLY SECURE AND RELATIVE TO ELEVATIONS AND DIMENSIONS IN THE DRAWINGS: TRUE TO PLUMB, LEVEL, SQUARE AND LINE. 2. ALL MATERIALS SHALL BE INSTALLED IN STRICT ACCORDANCE WITH THE MANUFACTURER'S WRITTEN SPECIFICATIONS OR MATERIAL'S INSTITUTE

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CONSULTANTS

2250 REGISTERED ARCHITECT BRETT HOLVERSTOTT STATE OF WASHINGTON

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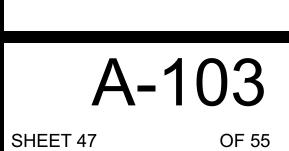
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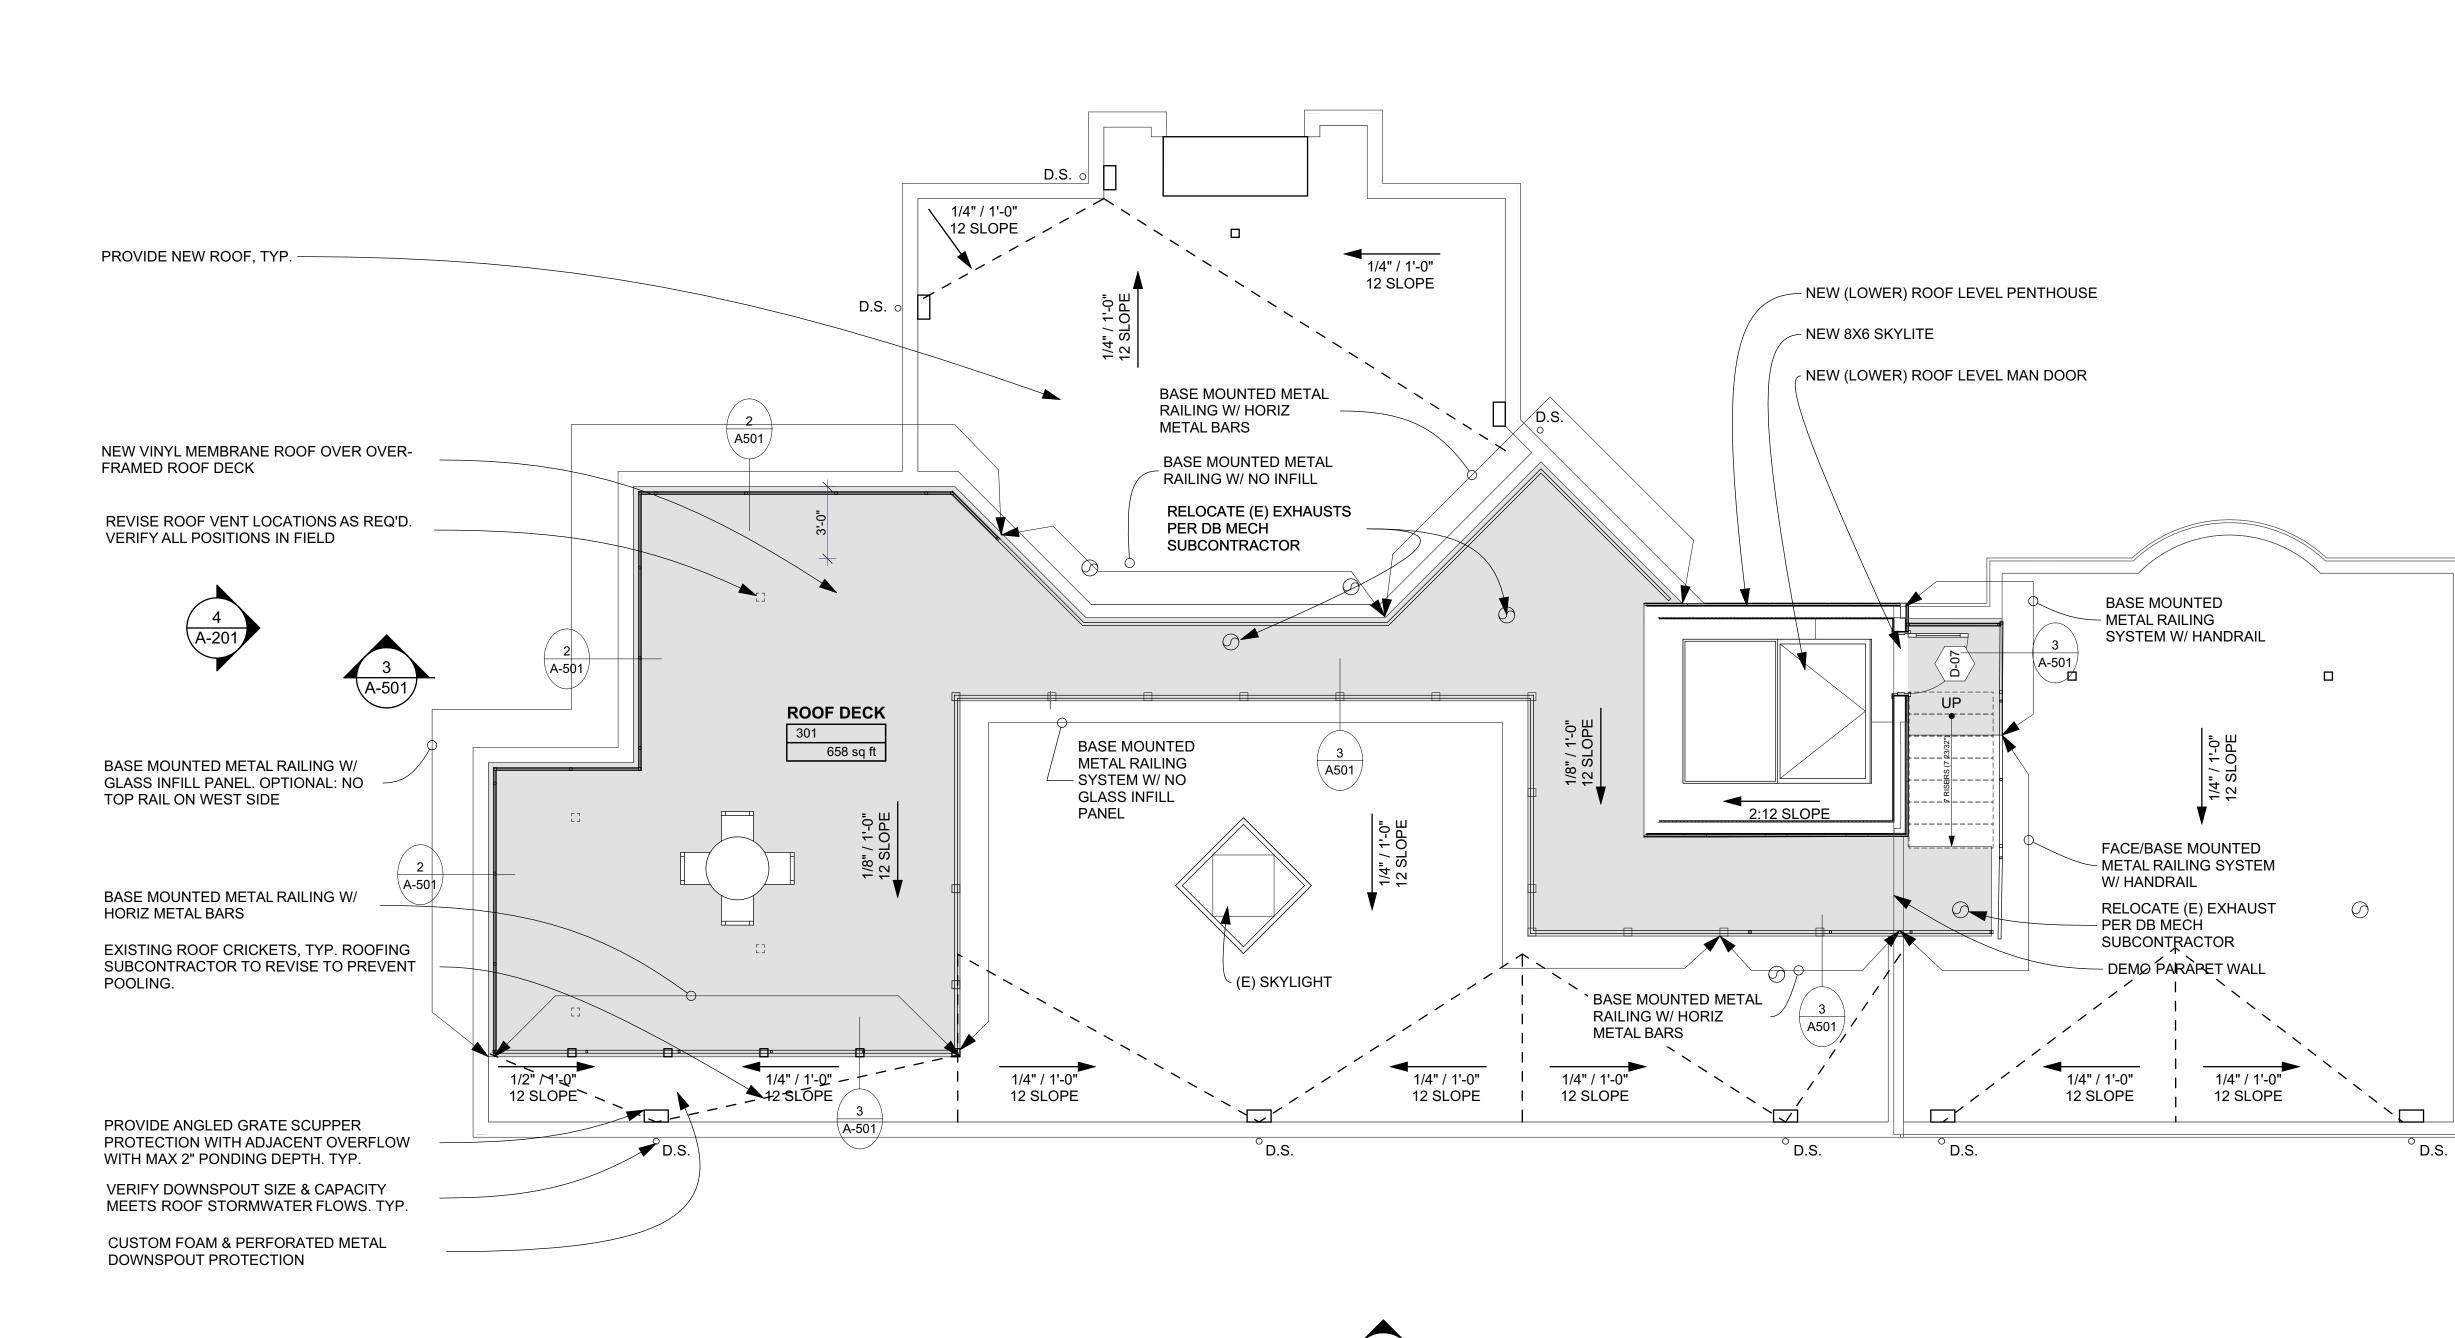
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SHEET TITLE

Second Floor Plan







ROOF PLAN 1 ` A-104 SCALE: 1/4" = 1'-0"





5. PROVIDE BLOCKING AS REQUIRED FOR ATTACHMENT OF ALL WALL HUNG CABINETS, FIXTURES, HANDRAILS, ACCESSORIES, SIDING AND DRYWALL. INSTALL 2X FIRE BLOCKING IN CONCEALED SPACES EVERY 10' HORIZONTALLY AND VERTICALLY. DRYWALL NOTES 1. WALL INSTALLATION: UNLESS NOTED OTHERWISE IN FIRE-RATED WALL ASSEMBLIES, INSTALL ½" DRYWALL BOARD OVER ¼" BEAD OF DRYWALL ADHESIVE. FASTEN WALL PANELS W/ 1 1/4" TYPE W SCREW SPACING NOT TO EXCEED 16" APART. 2. CEILING INSTALLATION: UNLESS NOTED OTHERWISE IN FIRE-RATED WALL ASSEMBLIES, INSTALL %" DRYWALL CEILING BOARD OVER 14" BEAD OF DRYWALL ADHESIVE. FASTEN CEILING PANELS W/ 1 1/4" TYPE W SCREWS NOT TO EXCEED 12" APART. 3. INSTALL WATER RESISTANT DRYWALL IN ALL WET AREAS. CEILING JOIST FRAMING NOT TO EXCEED 16" O.C. WHEN USING 5/" PANELS. 4. ALL DRYWALL CORNERS TO BE SQUARE CORNERS.

WALL FRAMING: 1. INSTALL CONTINUOUS SILL GASKETS UNDER ALL PLATES. 2. WOOD IN PERMANENT CONTACT WITH CONCRETE TO BE PRESSURE TREATED. ALL DIMENSIONAL FRAMING LUMBER TO BE KILN DRIED. 3. FLOOR SHEATHING TO BE GLUED AT EA. JOIST WITH 1/4" BEAD OF CONSTRUCTION ADHESIVE. 4. INSTALL (2) CONTINUOUS 2X STUDS BETWEEN EA. WINDOW UNIT (U.N.O). DOOR ROUGH OPENINGS TO BE A MIN OF 4 1/2" FROM INSIDE CORNER OF WALL FRAMING.

WALL FRAMING & DRYWALL NOTES

PLAN NOTES

PRIOR TO COMMENCING WITH FRAMING.

WORKMANSHIP:

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1. WORKMANSHIP SHALL CONFORM TO THE BEST AND HIGHEST STANDARDS OF QUALITY IN EACH TRADE. ALL WORK SHALL BE FIRMLY SECURE AND RELATIVE TO ELEVATIONS AND DIMENSIONS IN THE DRAWINGS: TRUE TO PLUMB, LEVEL, SQUARE AND LINE. 2. ALL MATERIALS SHALL BE INSTALLED IN STRICT ACCORDANCE WITH THE MANUFACTURER'S WRITTEN SPECIFICATIONS OR MATERIAL'S INSTITUTE

DIMENSIONING: 1. DIMENSIONS SHALL TAKE PRECEDENCE OVER GRAPHIC REPRESENTATION. DO NOT SCALE THE DRAWINGS. 2. DOORS AND WINDOWS ARE DIMENSIONED TO THE CENTER OF ROUGH OPENINGS. 3. ALL DIMENSIONS ARE GIVEN FROM FACE OF FRAMING UNLESS NOTED OTHERWISE. FOUNDATION PLANS ARE DIMENSIONED FROM FACE OF CONCRETE. 4. SHOULD DIMENSIONAL DISCREPANCIES OCCUR, THE CONTRACTOR SHALL CONSULT THE DESIGNER BEFORE PROCEEDING WITH WORK. 5. CONTRACTOR TO PROVIDE DESIGNER MANUFACTURER SHOP DRAWINGS & SUBMITTALS FOR ALL CUSTOM FABRICATED ITEMS PRIOR TO ORDERING OR

FABRICATION OF ITEMS. THE CONTRACTOR SHALL VERIFY ALL DIMENSIONS IN THE FIELD BEFORE SHOP DRAWINGS ARE MADE AND BEFORE ANY WORK IS CONSTRUCTED OR FABRICATED. 6. INTERIOR FLOOR AREA IS MEASURED TO THE EXTERIOR FACE OF FRAMING. THE STAIRWAYIS COUNTED AS SQUARE FOOTAGE ON ALL FLOORS. 7. ACCESSORY DWELLING FLOOR AREAS ARE MEASURED TO THE INTERIOR FACE OF WALL UNLESS NOTED OTHERWISE. 8. SITE AREAS PERTAINING TO LOT COVERAGE OR DRAINAGE ARE TO BE MEASURED ACCORDING TO THE REQUIREMENTS OF THE JURISDICTION. 9. VERIFY ROUGH OPENING AND CLEARANCE REQUIREMENTS OF ALL FIXTURES

PLAN REVIEW/INSPECTOR CHANGES: PLAN REVIEW/INSPECTOR CHANGES. 1. THE DESIGNER SHALL NOT BE HELD RESPONSIBLE FOR CHANGES REQUESTED BY PLAN REVIEWERS AND/OR FIELD INSPECTORS OF THE GOVERNMENTAL AUTHORITIES HAVING JURISDICTION OVER THIS WORK. 2. SHOULD AN AUTHORITY FIND A CONFLICT WITH CODE OR REGULATIONS, THE CONTRACTOR SHALL CONSULT THE DESIGNER BEFORE PROCEEDING WITH WORK.

LIFE & SAFETY 1. PER NFPA 72 & SECTION R314 COMBINATION SMOKE AND CARBON MONOXIDE ALARMS TO BE INSTALLED, ALL DEVICES SHALL BE INTERCONNECTED IN SUCH A MANNER THAT THE ACTUATION OF ONE ALARM WILL ACTIVATE ALL ALARMS. DETECTORS SHALL BE CONNECTED TO THE BUILDING'S POWER SUPPLY. IN THE EVENT BUILDING POWER IS INTERRUPTED DETECTOR SHALL RECEIVE POWER FROM A BATTERY BACKUP. 2. COMBINATION SMOKE ALARM & CARBON MONOXIDE ALARM TO BE INSTALLED IN: EACH SLEEPING ROOM; OUTSIDE SLEEPING AREAS ON ALL FLOORS; CENTRALLY LOCATED ON EVERY FLOOR; IN EACH LOCATION WHERE THERE IS A CEILING HT. CHANGE GREATER THAN 24" 3. ALL EGRESS WINDOW & DOORS TO MEET THE REQUIREMENTS OF SECTION R310 EMERGENCY ESCAPE AND RESCUE OPENINGS. ALL DOOR AND WINDOW GLAZING TO MEET THE SAFETY GLASS / TEMPERING REQUIREMENTS OF SECTION R308. ALL SILL HEIGHTS BELOW 24" TO BE PROTECTED FROM FALL HAZARD.



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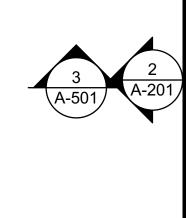


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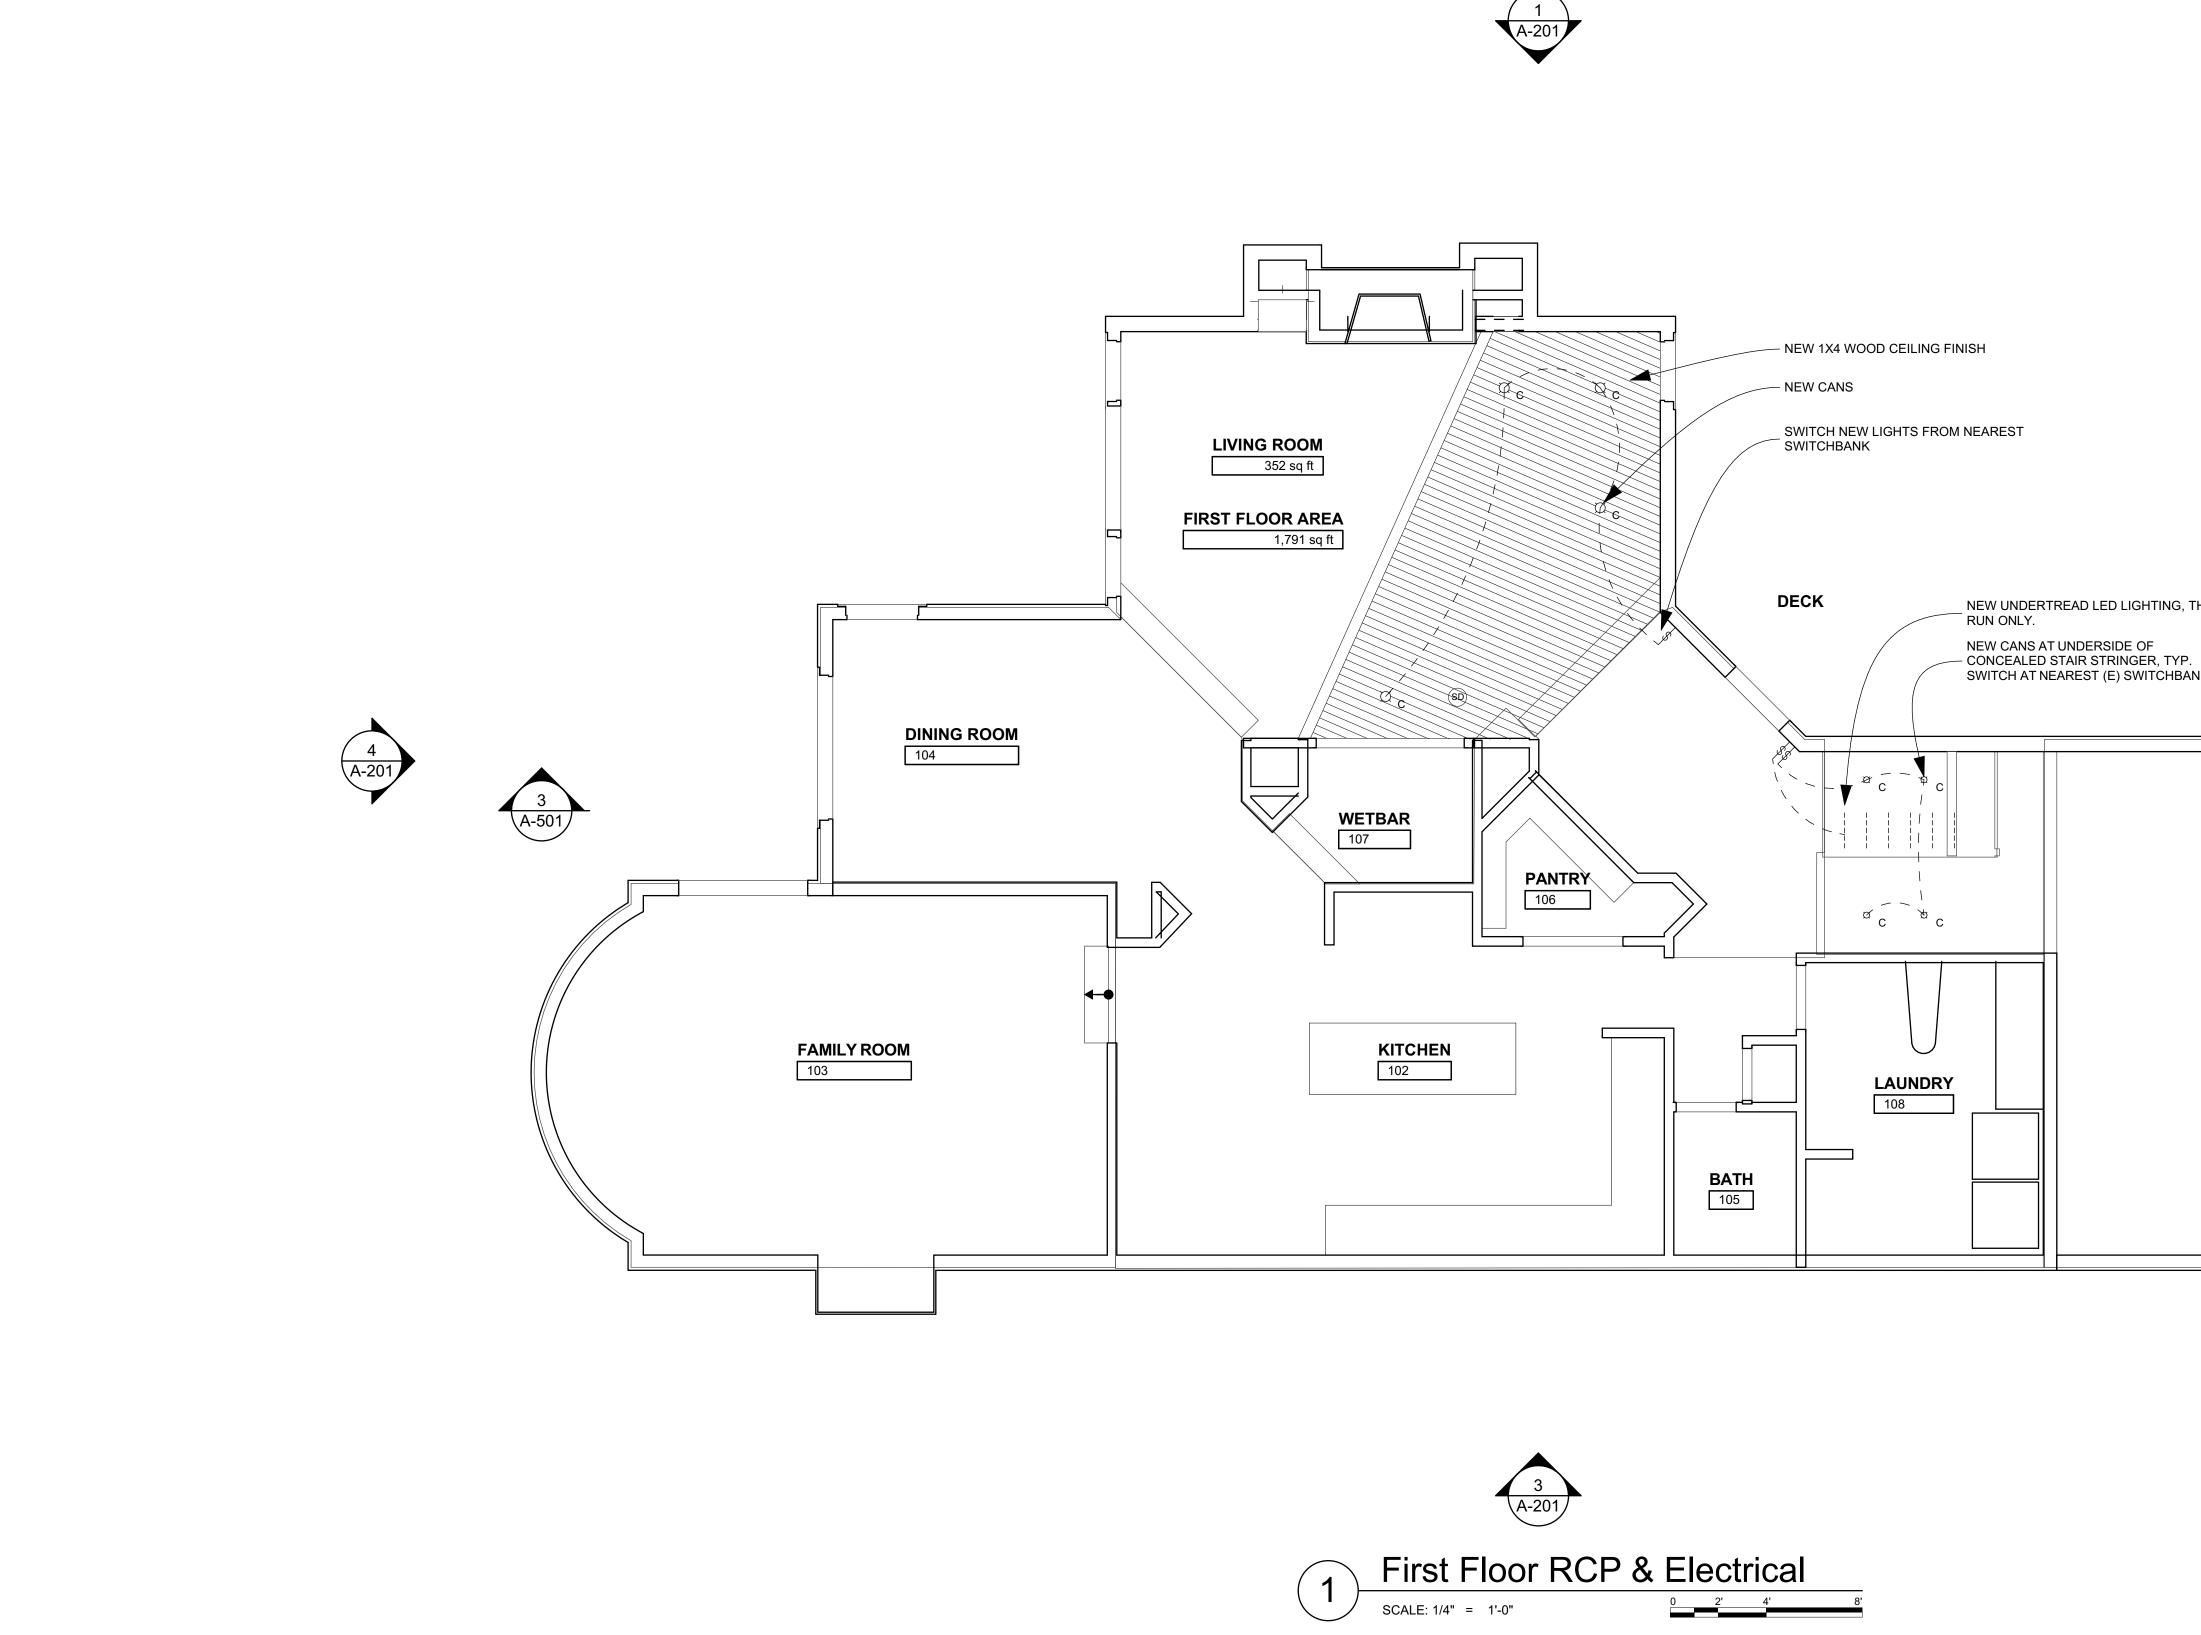
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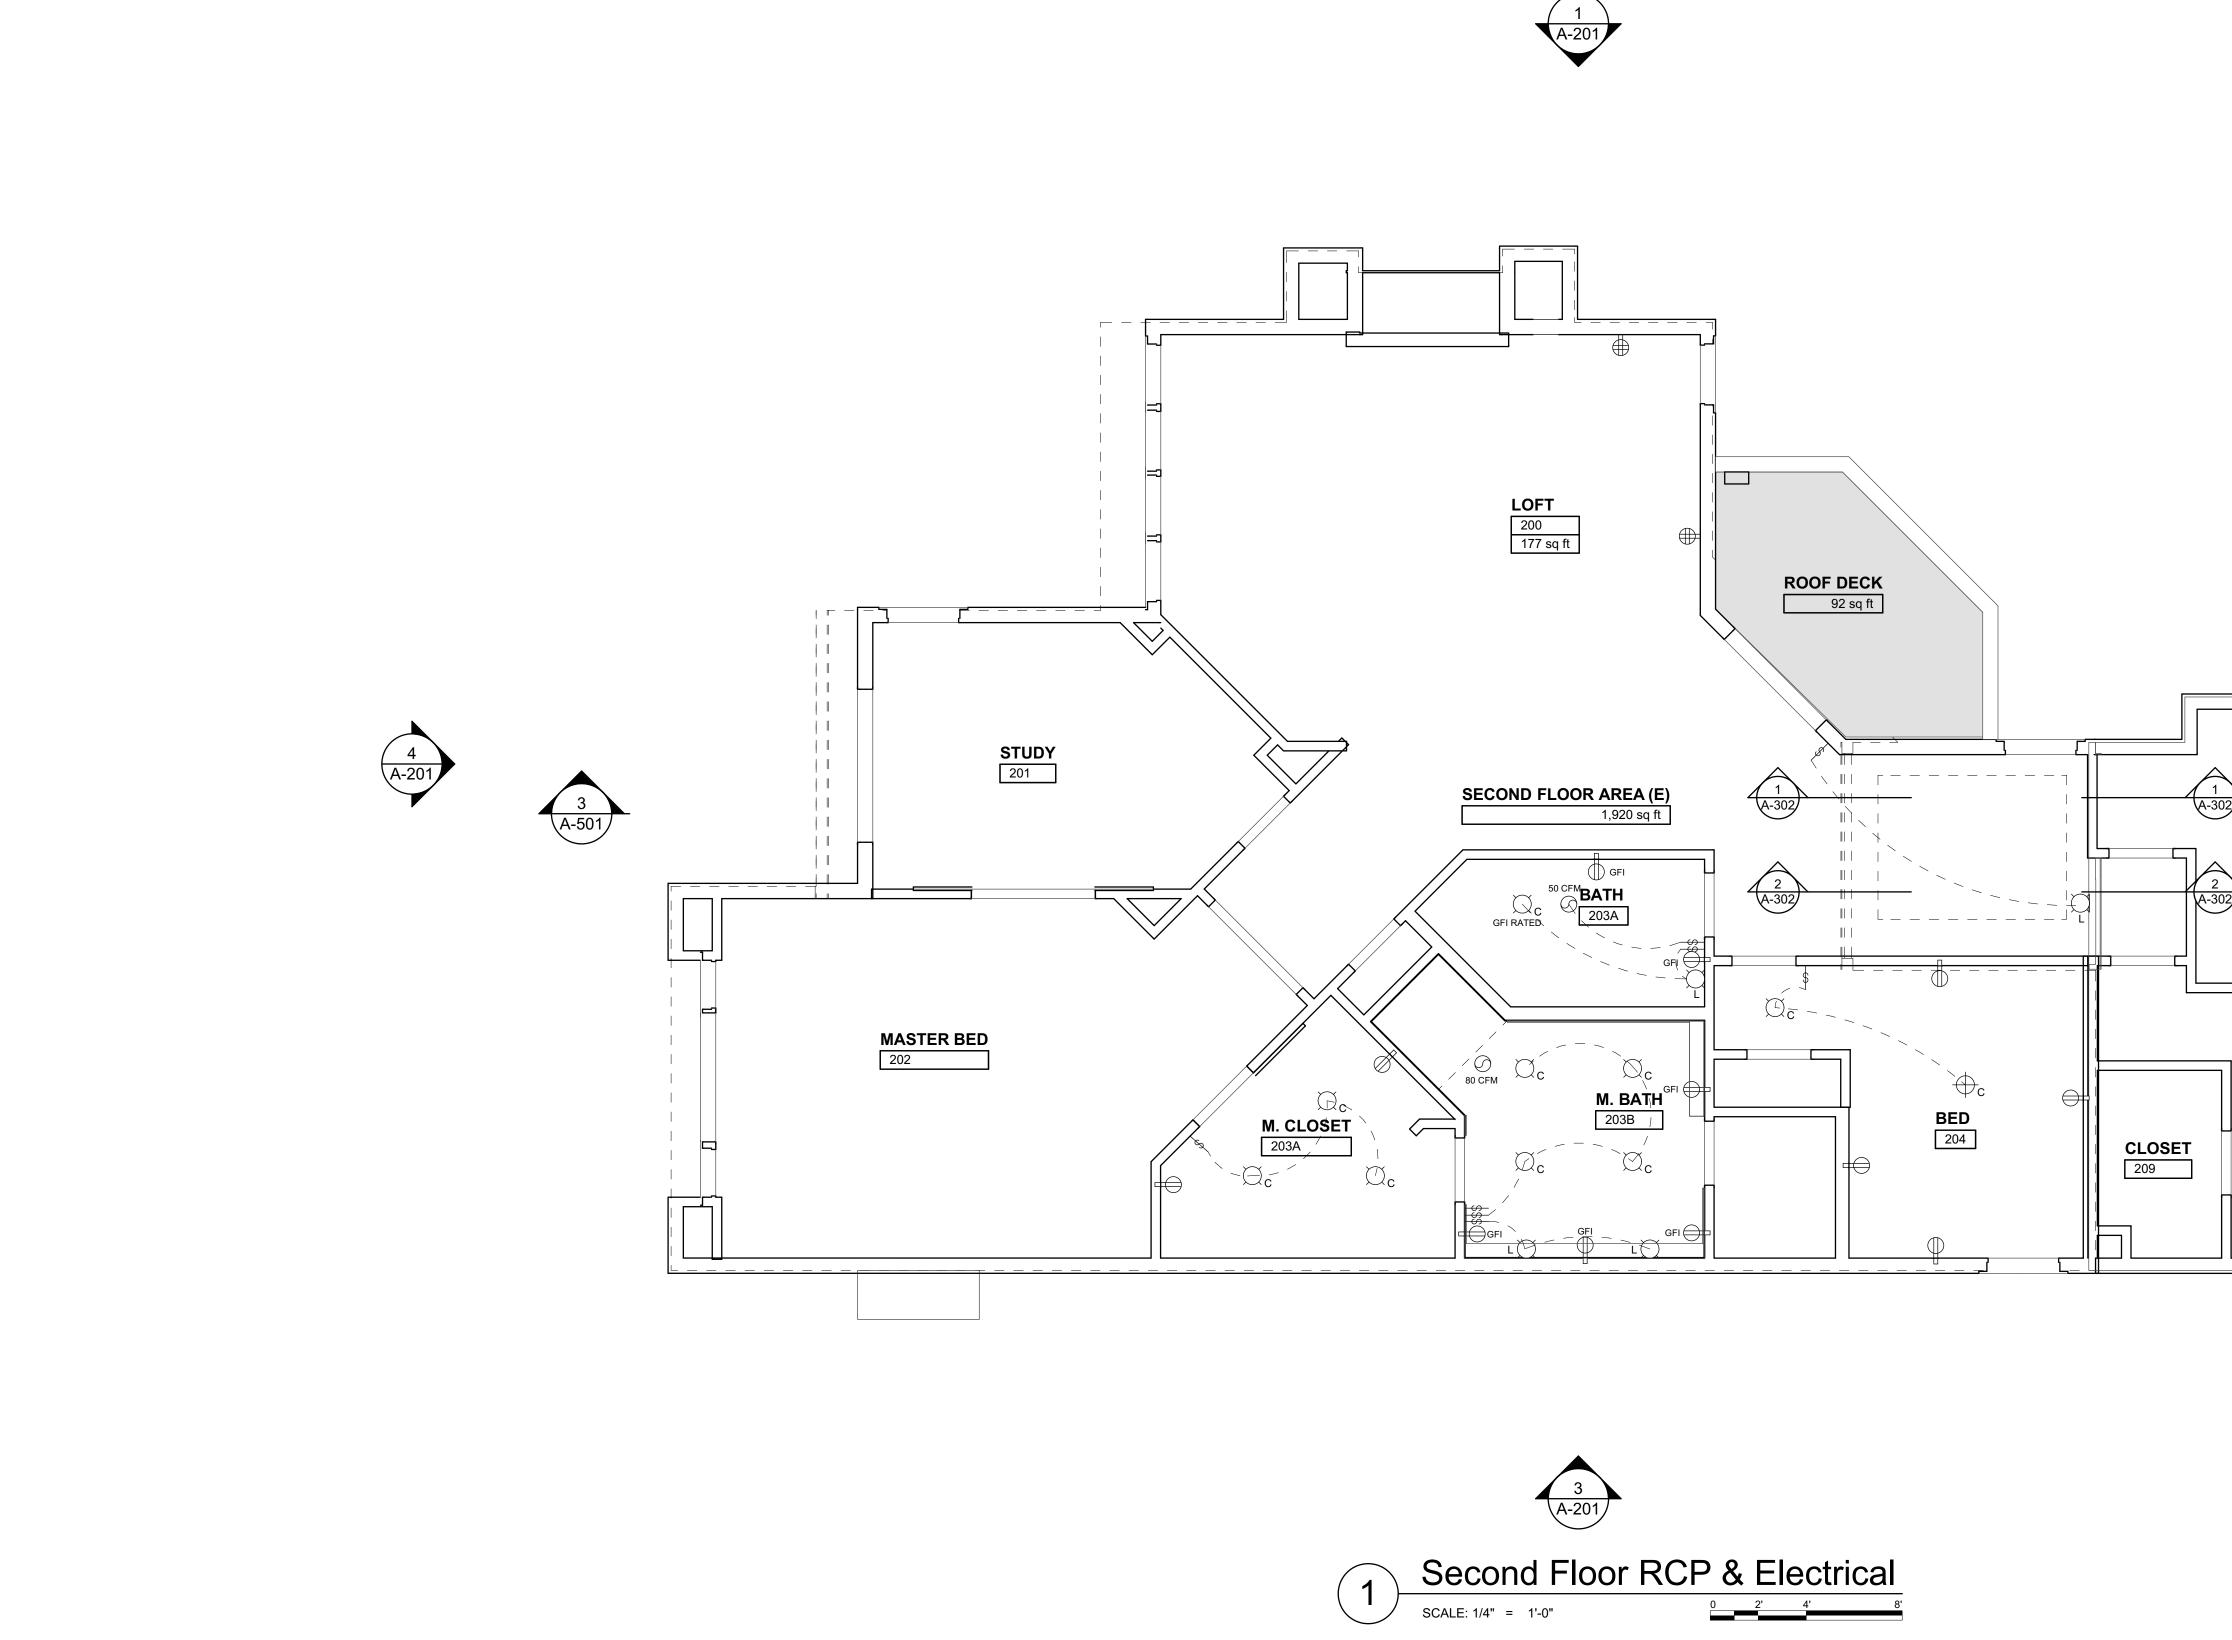
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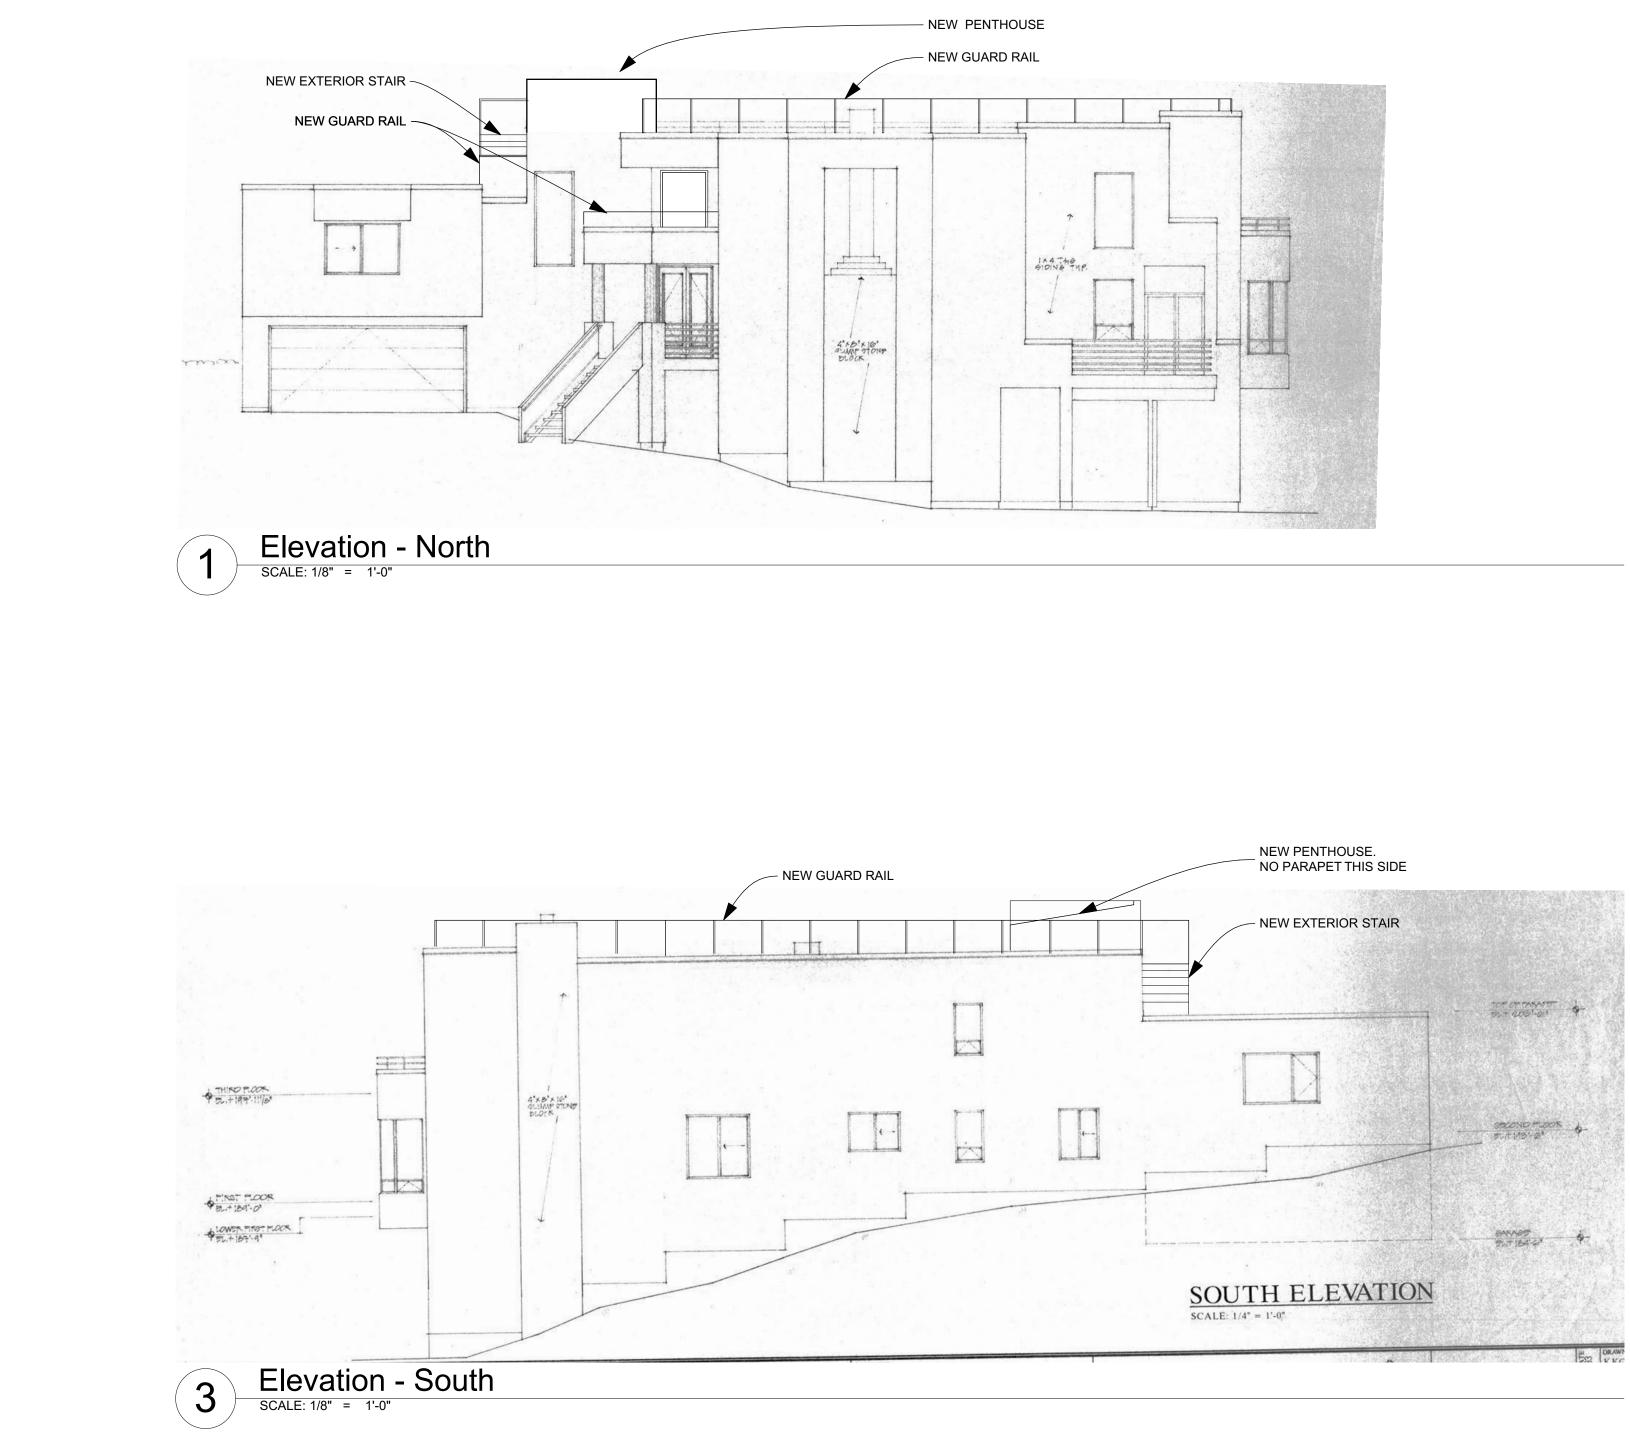


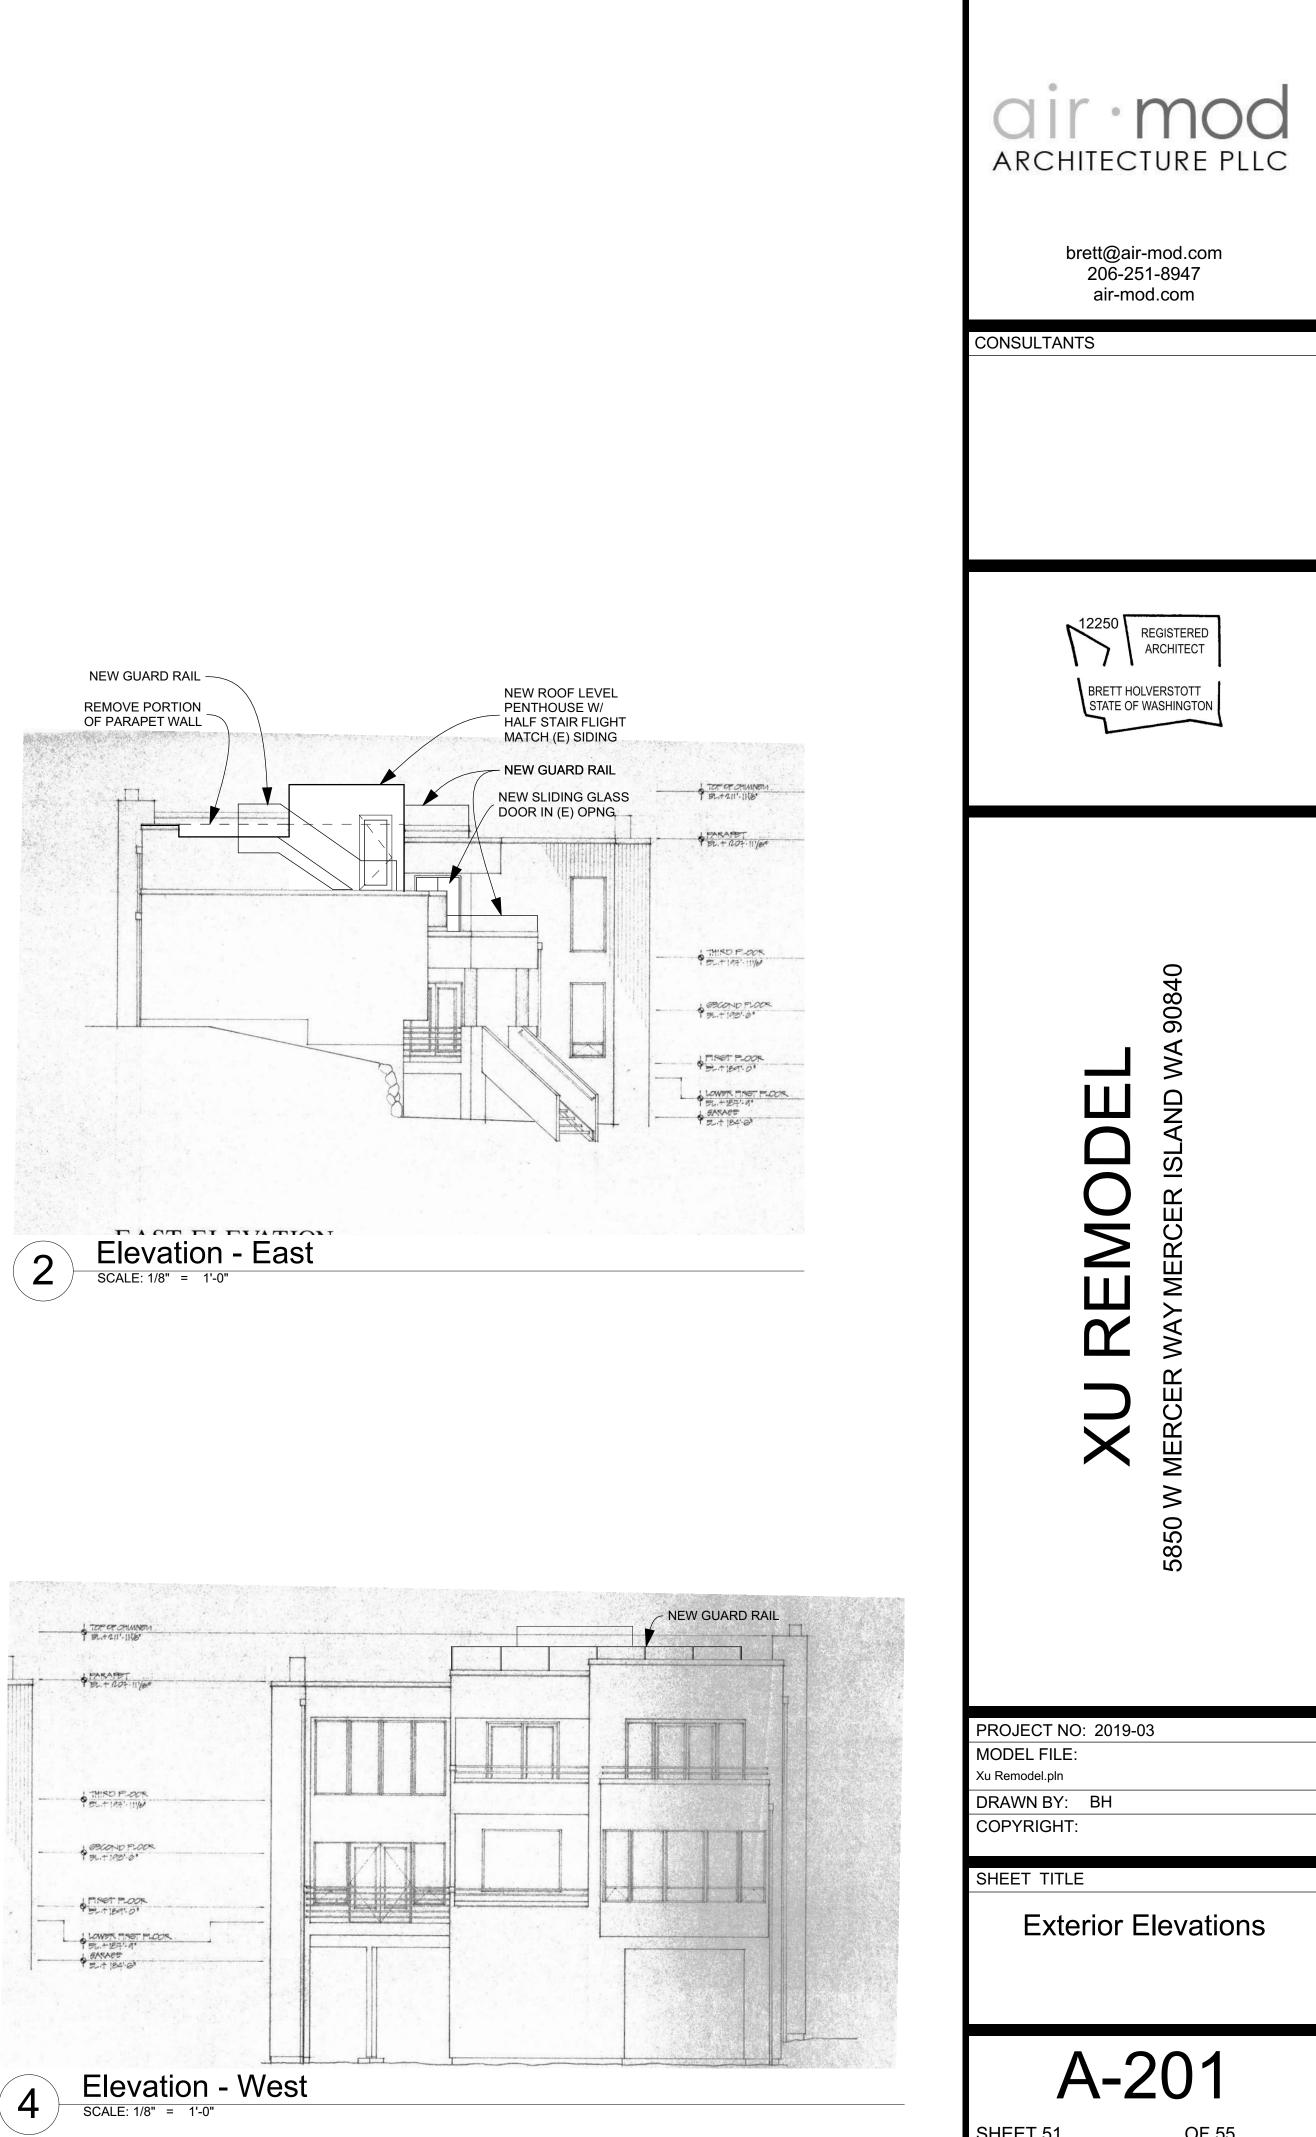
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тиз мк GARAGE 110 482 sq ft	XU REMODEL 5850 M MERCER ISLAND WA 90840
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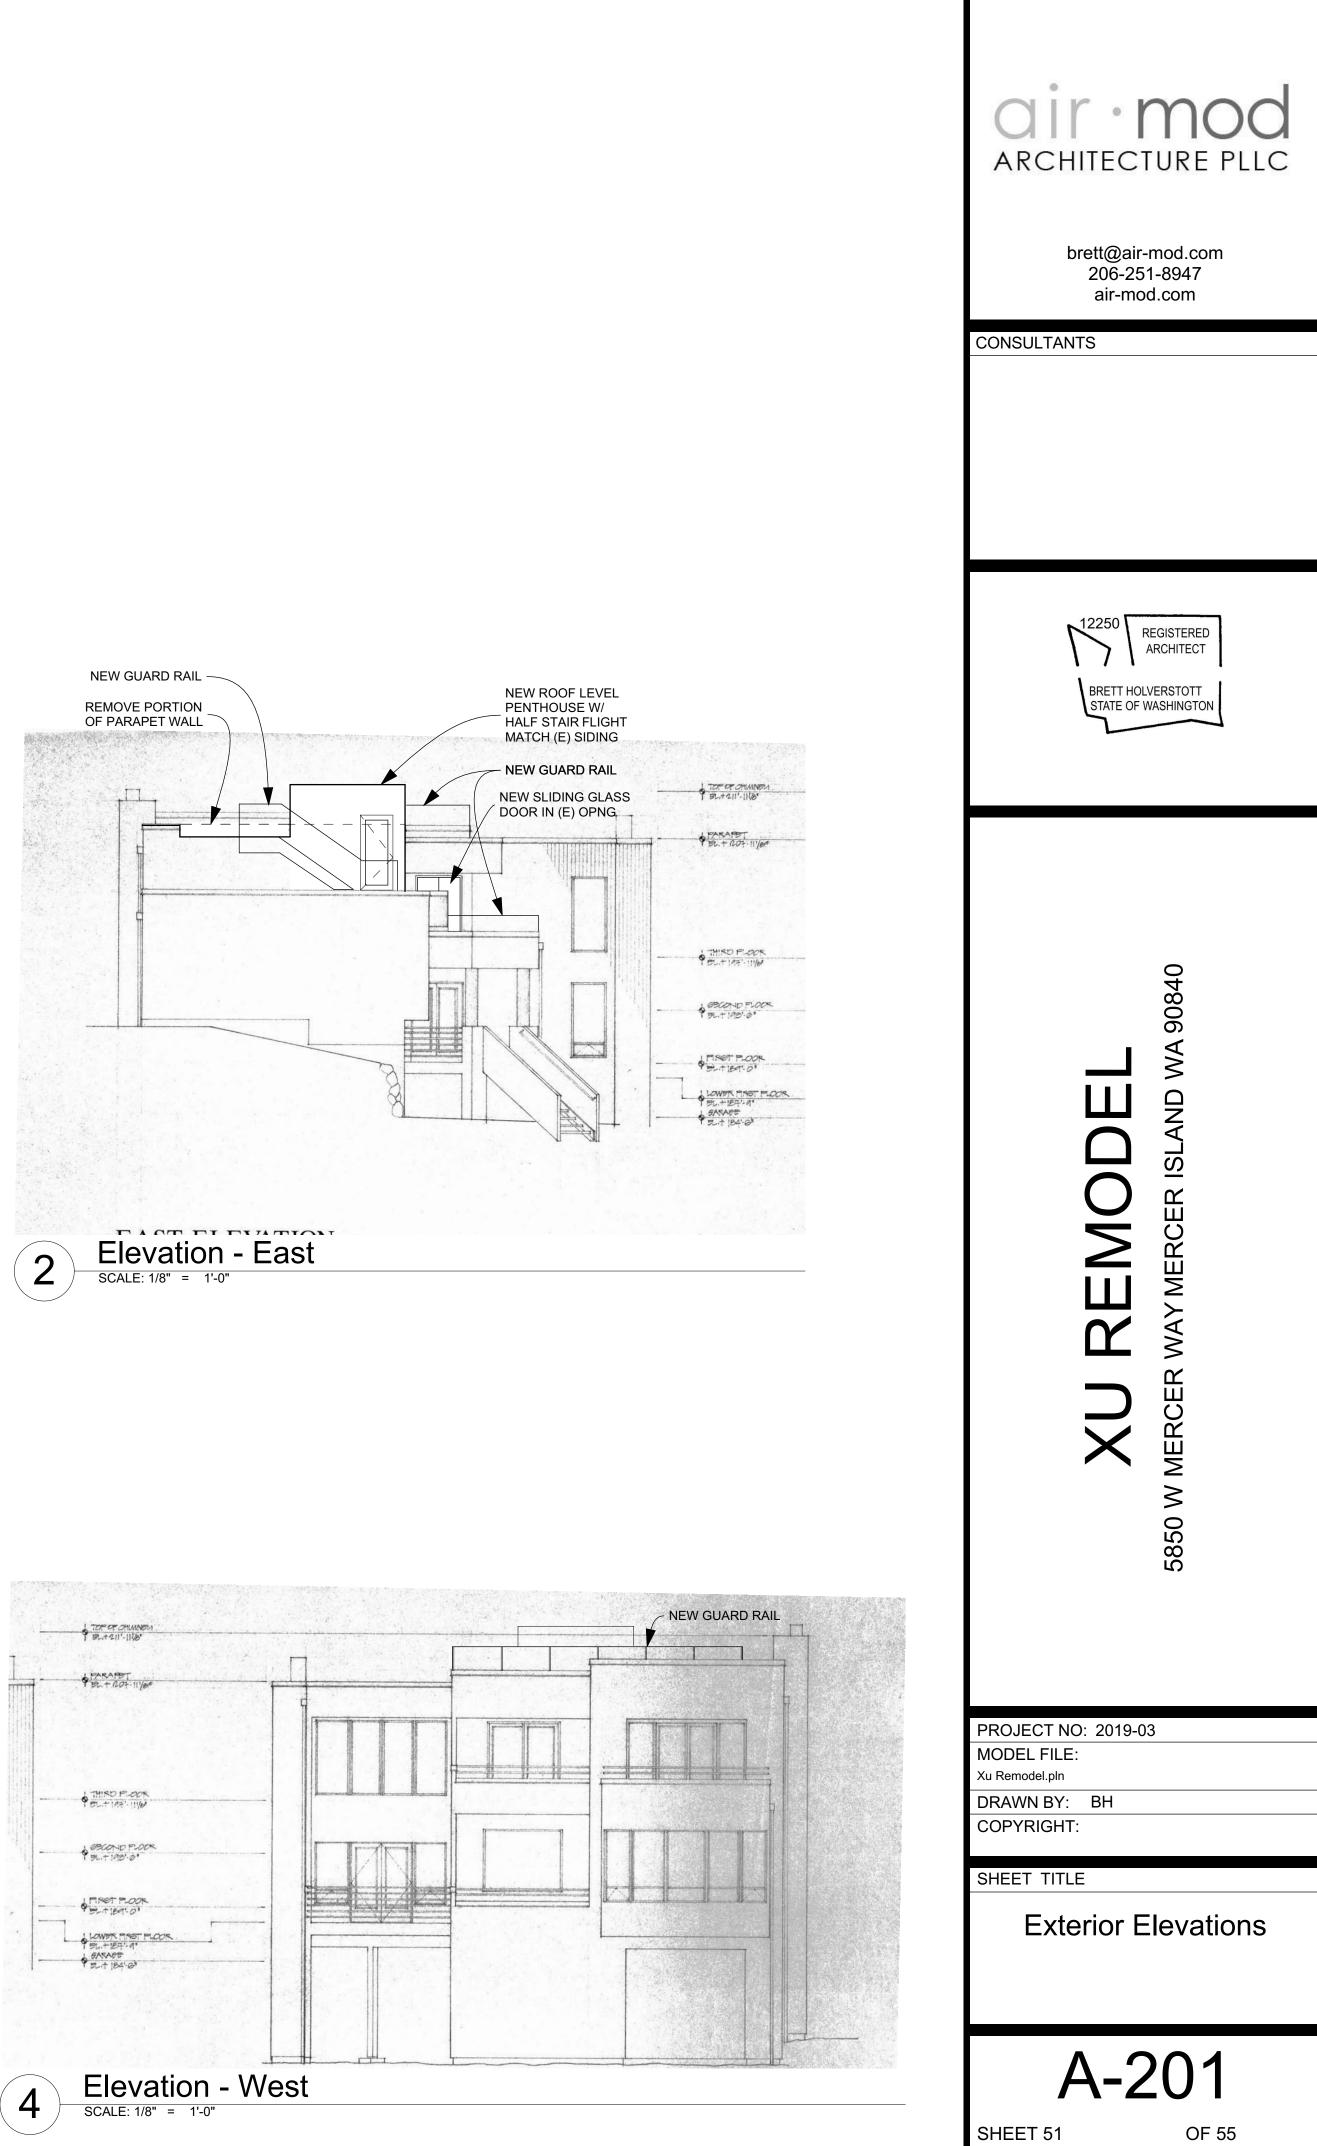
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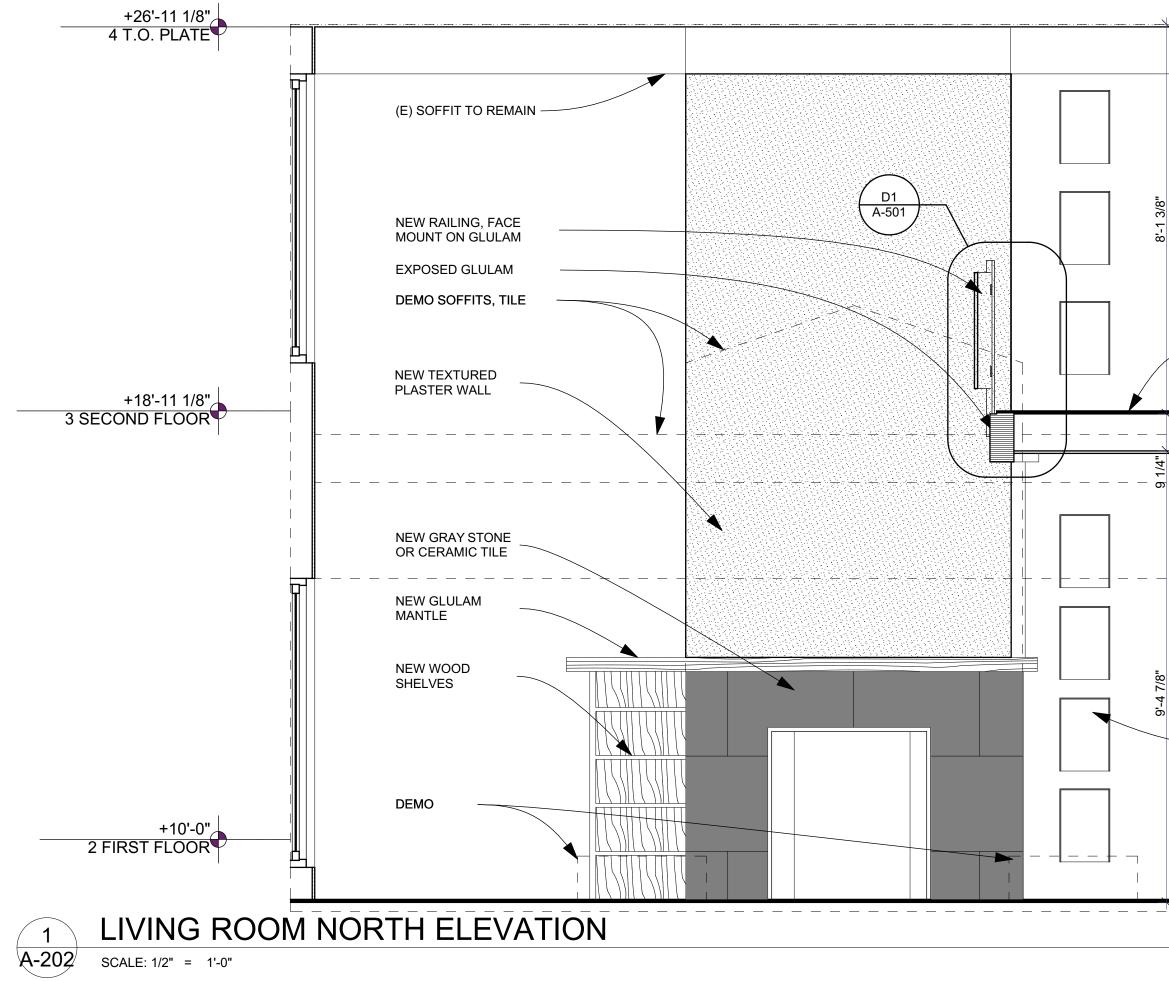
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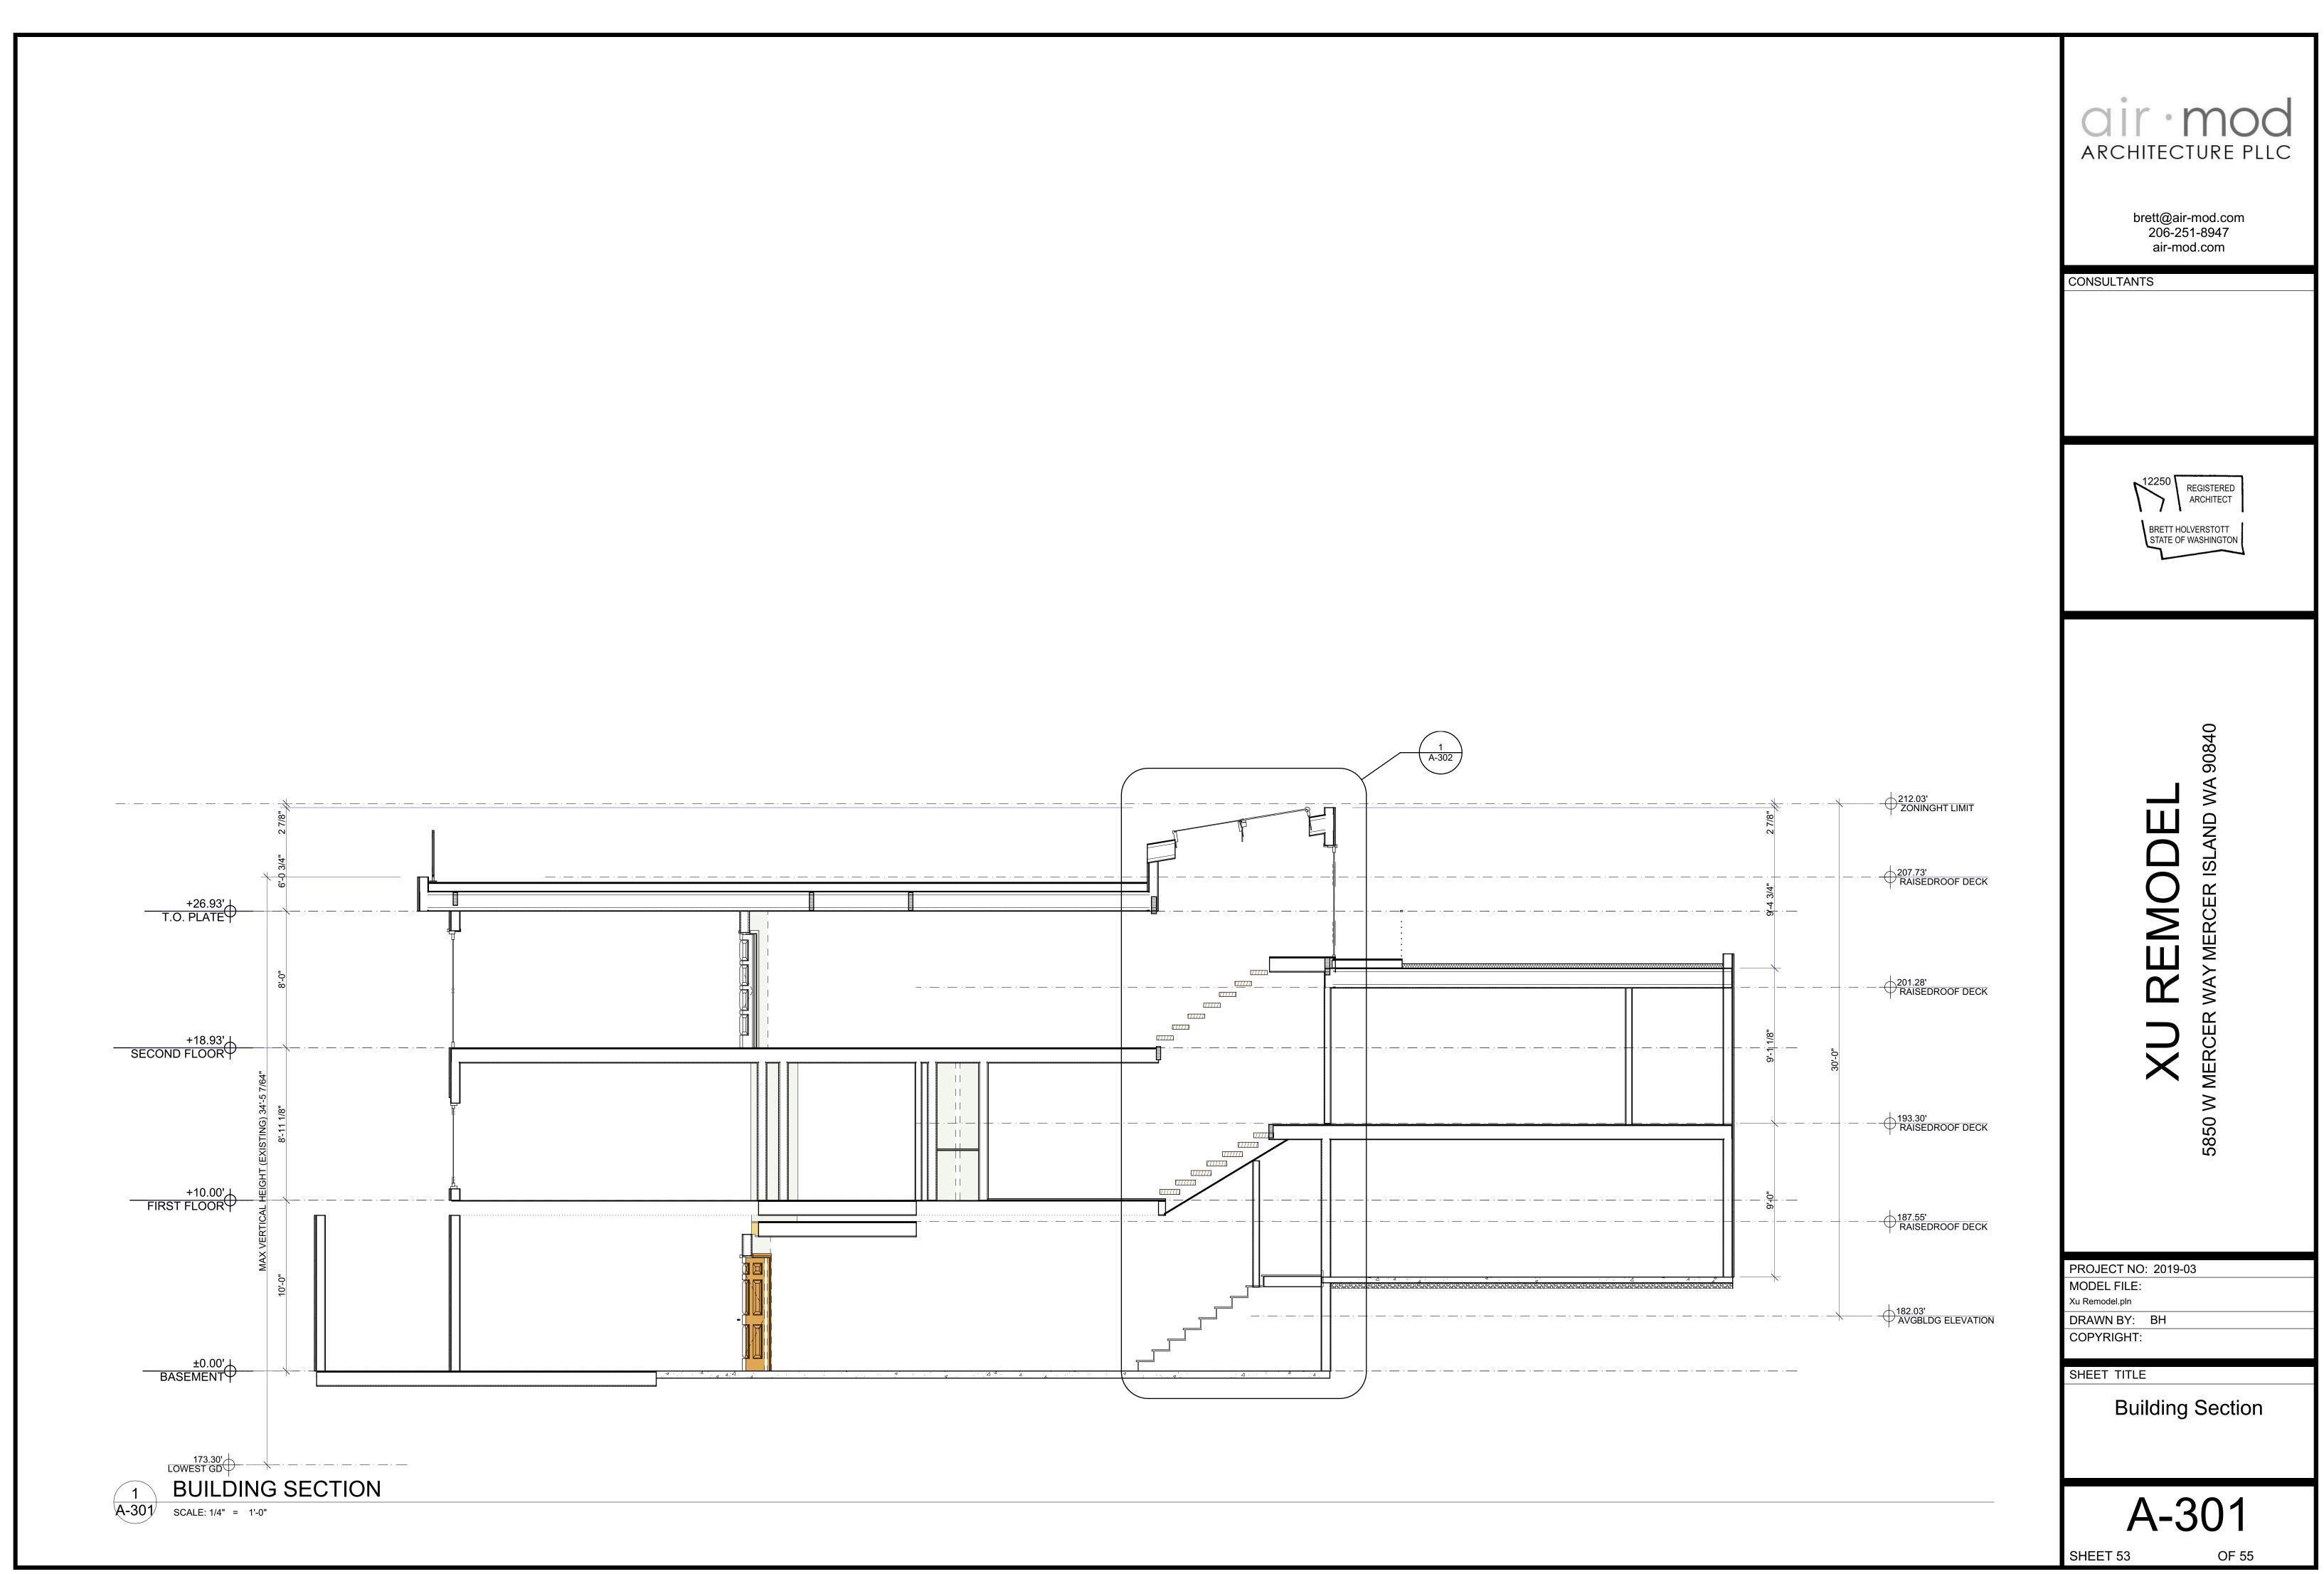




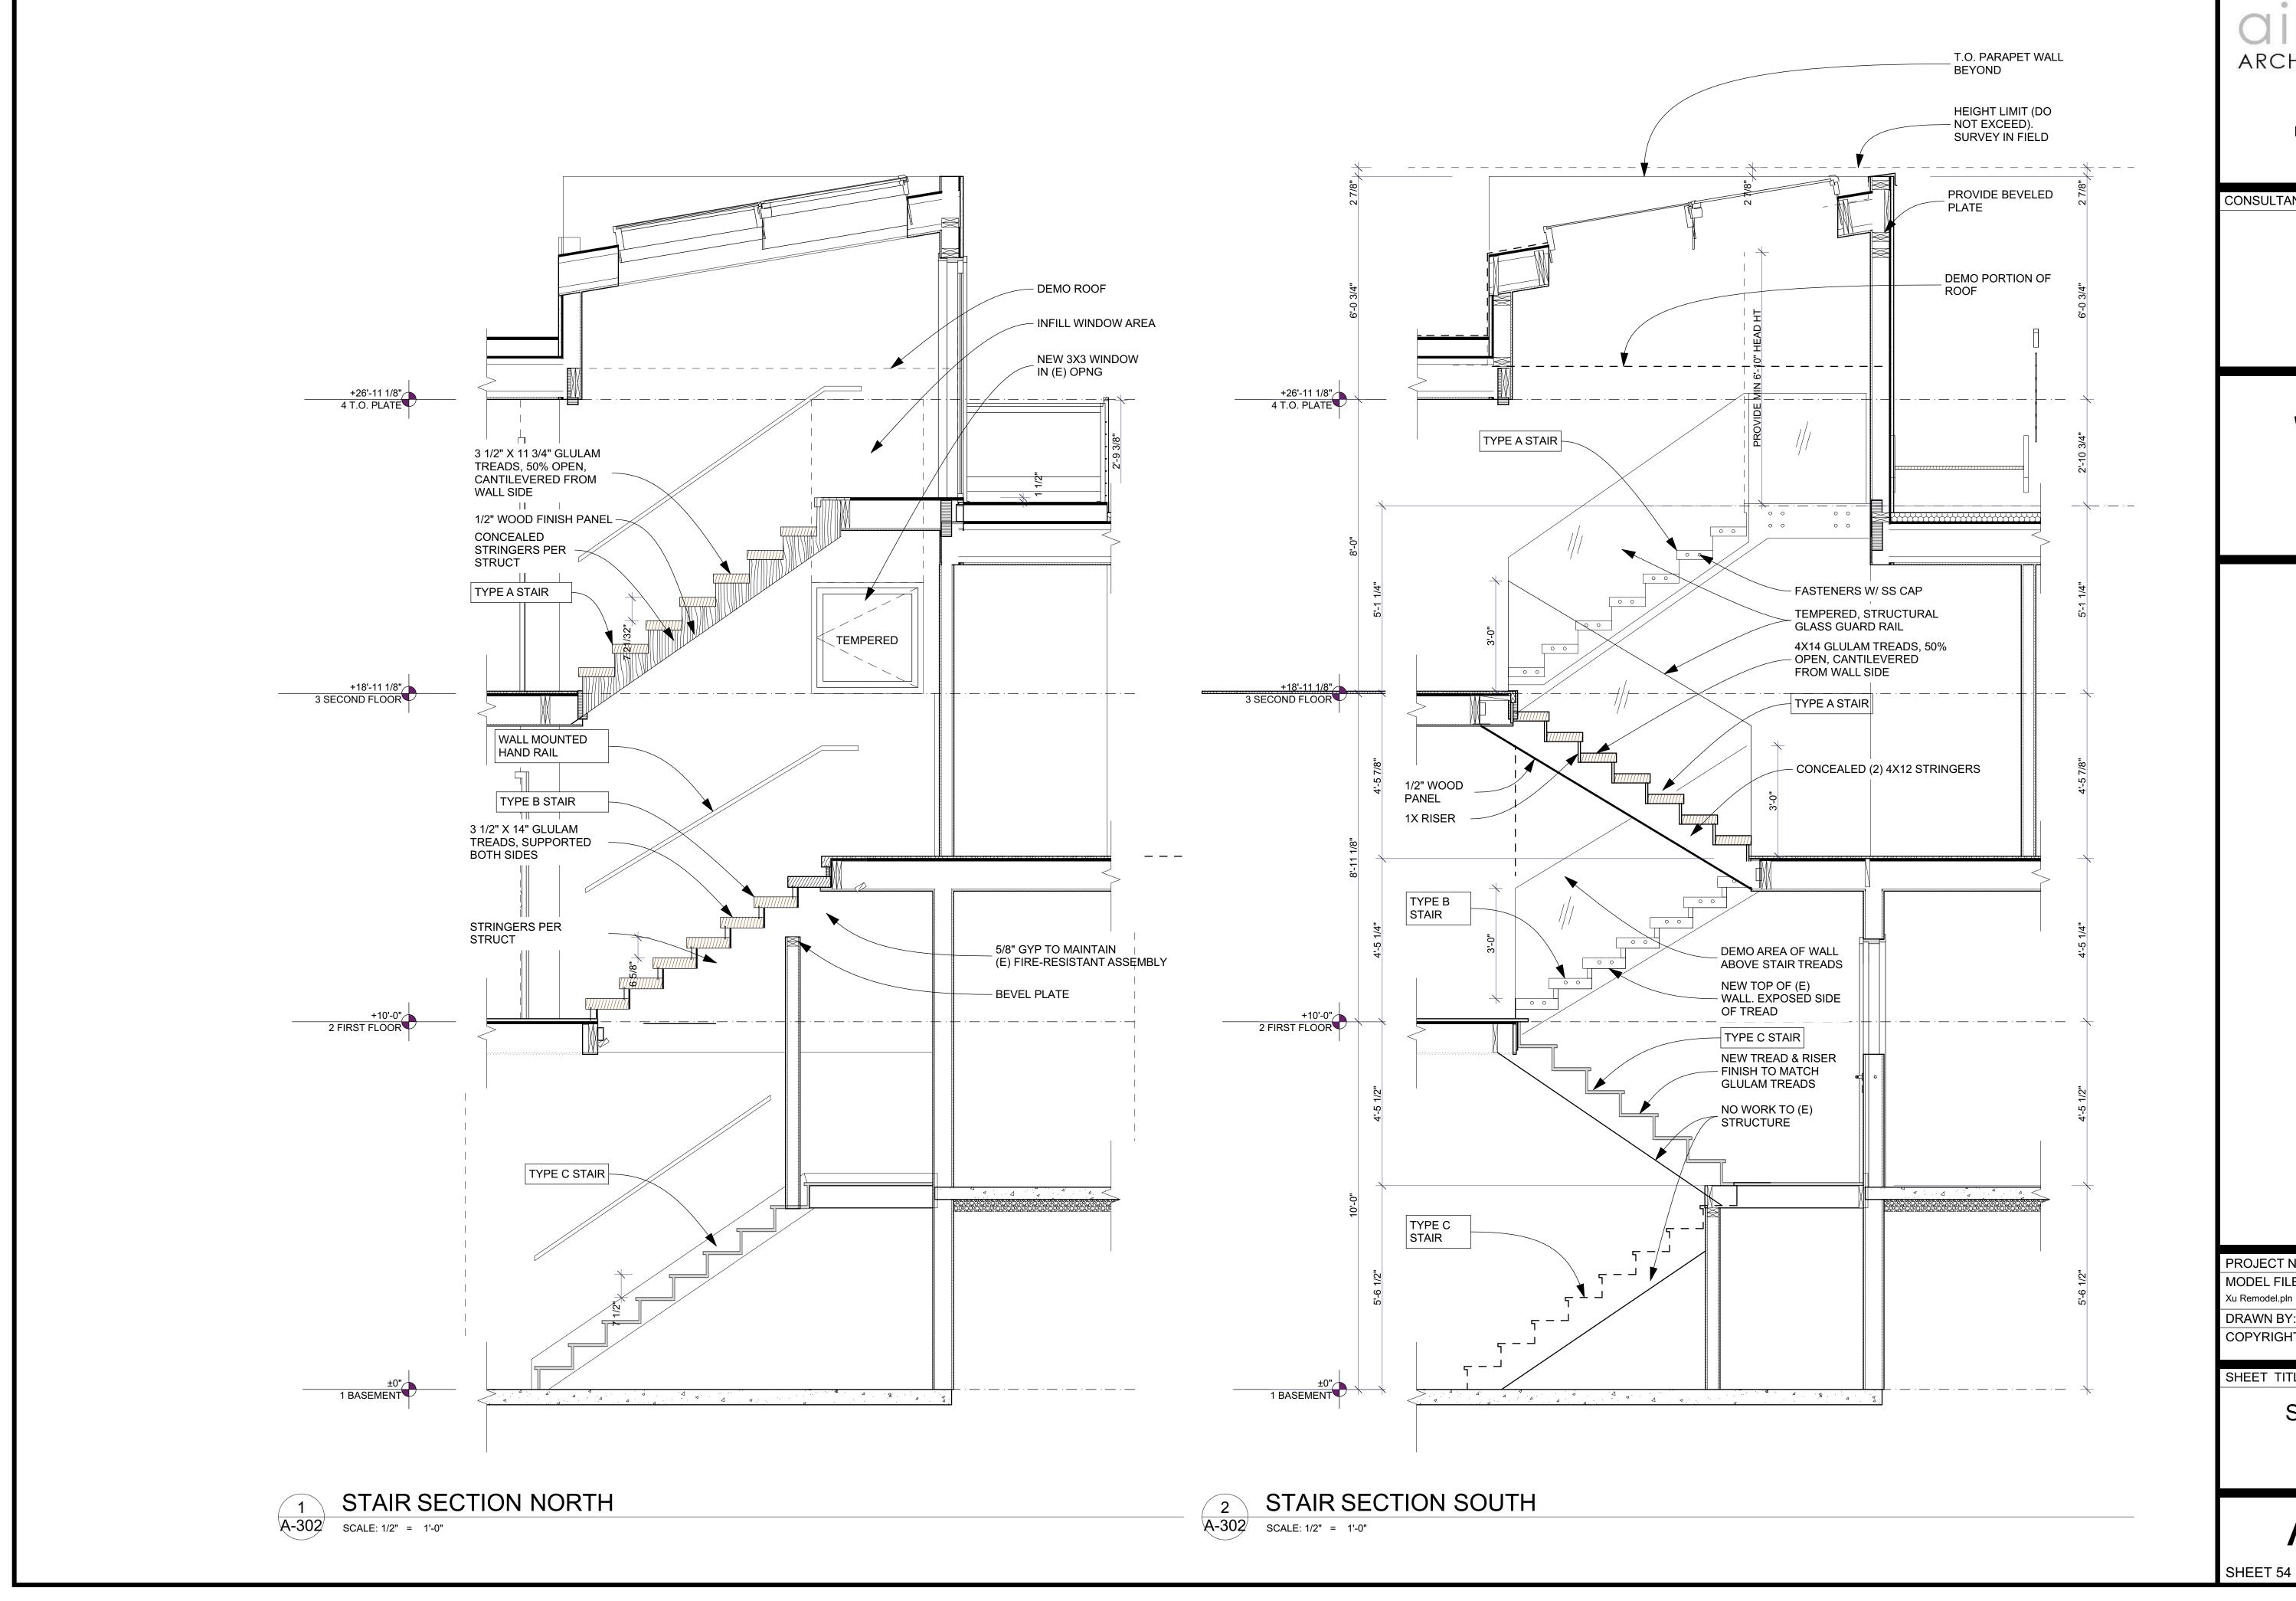
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		consultants consultants
		REGISTERED ARCHITECT BRETT HOLVERSTOTT STATE OF WASHINGTON
	+26'-11 1/8" 4 T.O. PLATE	EMDDEL Mercer Island WA 90840
NEW LOFT	+18'-11 1/8" 3 SECOND FLOOR	SB50 W MERCER WAY MERCER IS
TINSET SHELVES W/ BUILT IN LIGHTING	+10'-0" 2 FIRST FLOOR	PROJECT NO: 2019-03 MODEL FILE: Xu Remodel.pln DRAWN BY: BH COPYRIGHT: SHEET TITLE Interior Elevations
		A-202 SHEET 52 OF 55



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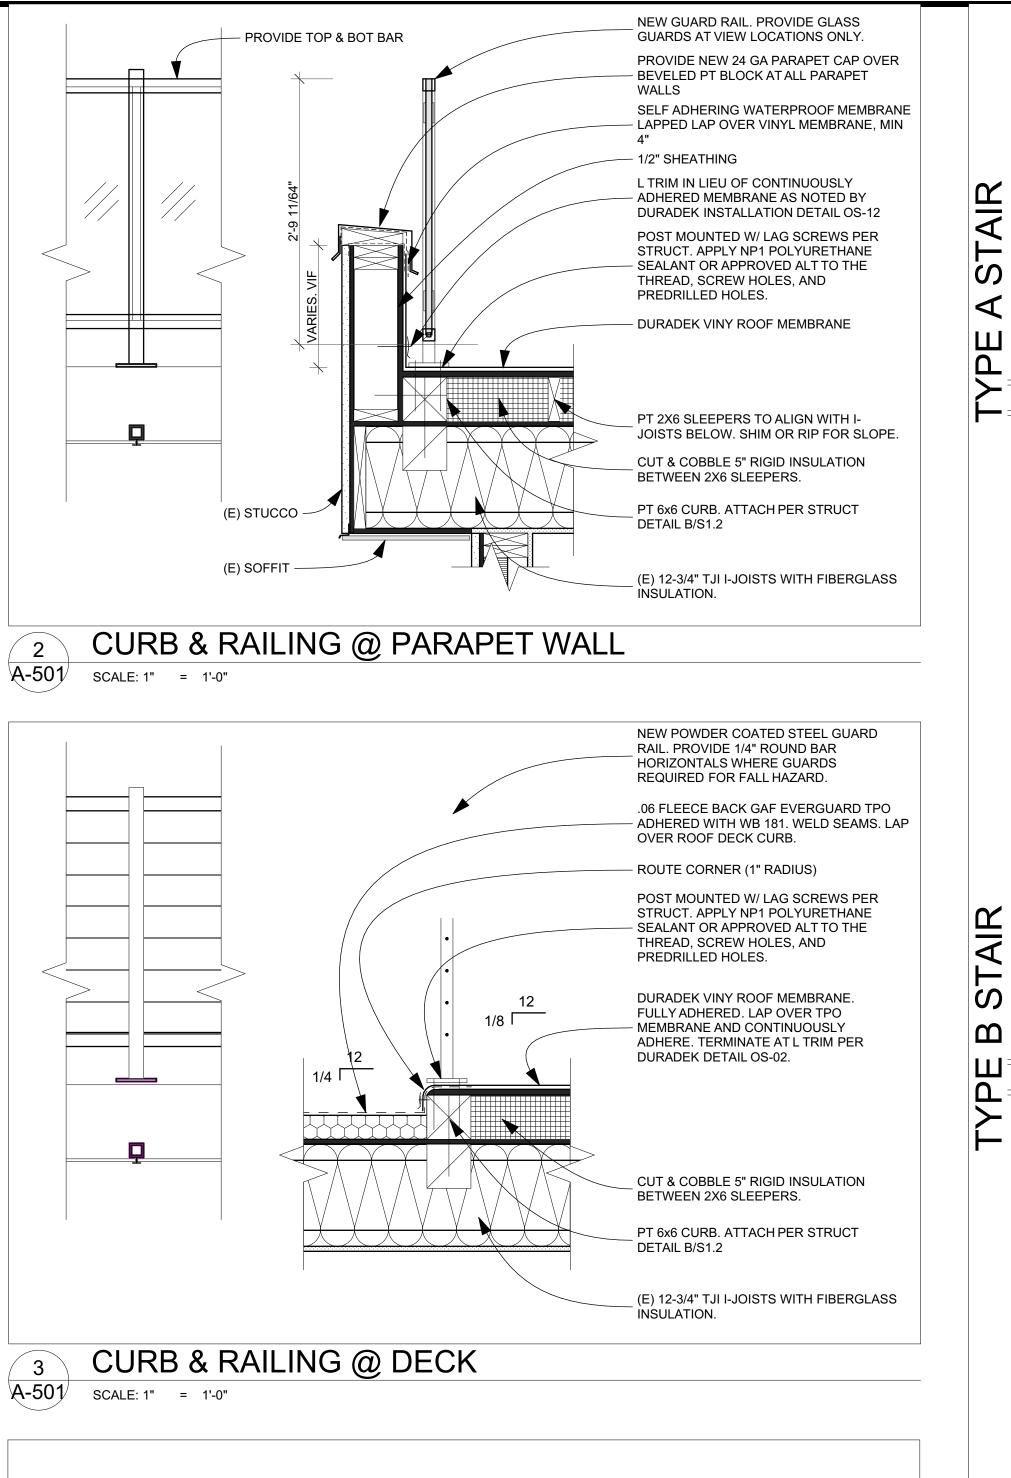


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SB50 W MERCER ISLAND WA 90840
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Stair Sections A-302

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2'-0"

2'-0"

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WALL SIDE

1

A-501 SCALE: 1" = 1'-0"

WALL

SIDE

11

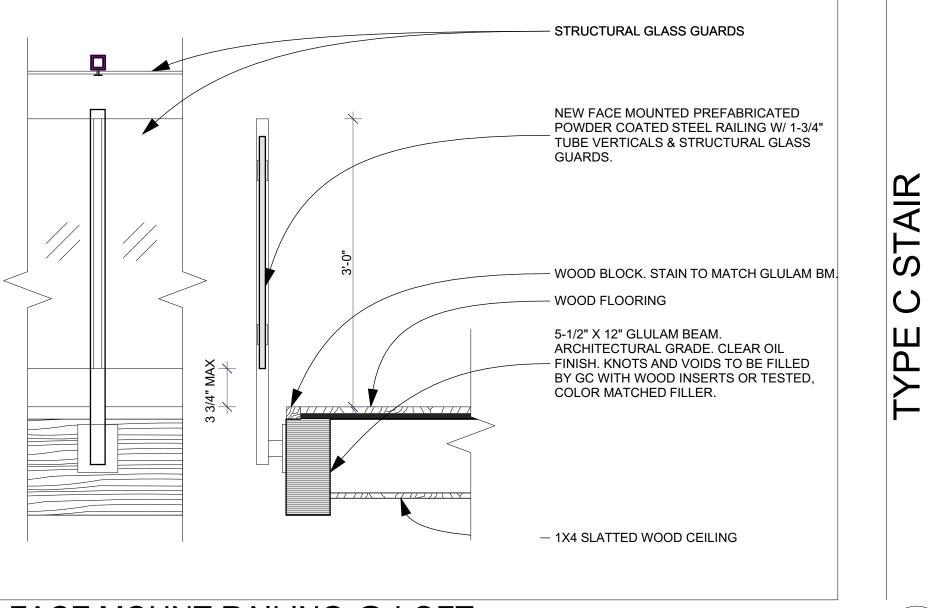
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11

WALL SIDE



FACE MOUNT RAILING @ LOFT SCALE: 1" = 1'-0"

